

COVER SHEET

a2000

PROPOSED ADDITION FOR
GILBERT SCALES
8708 FLOWER ST BELLFLOWER, CA 90706

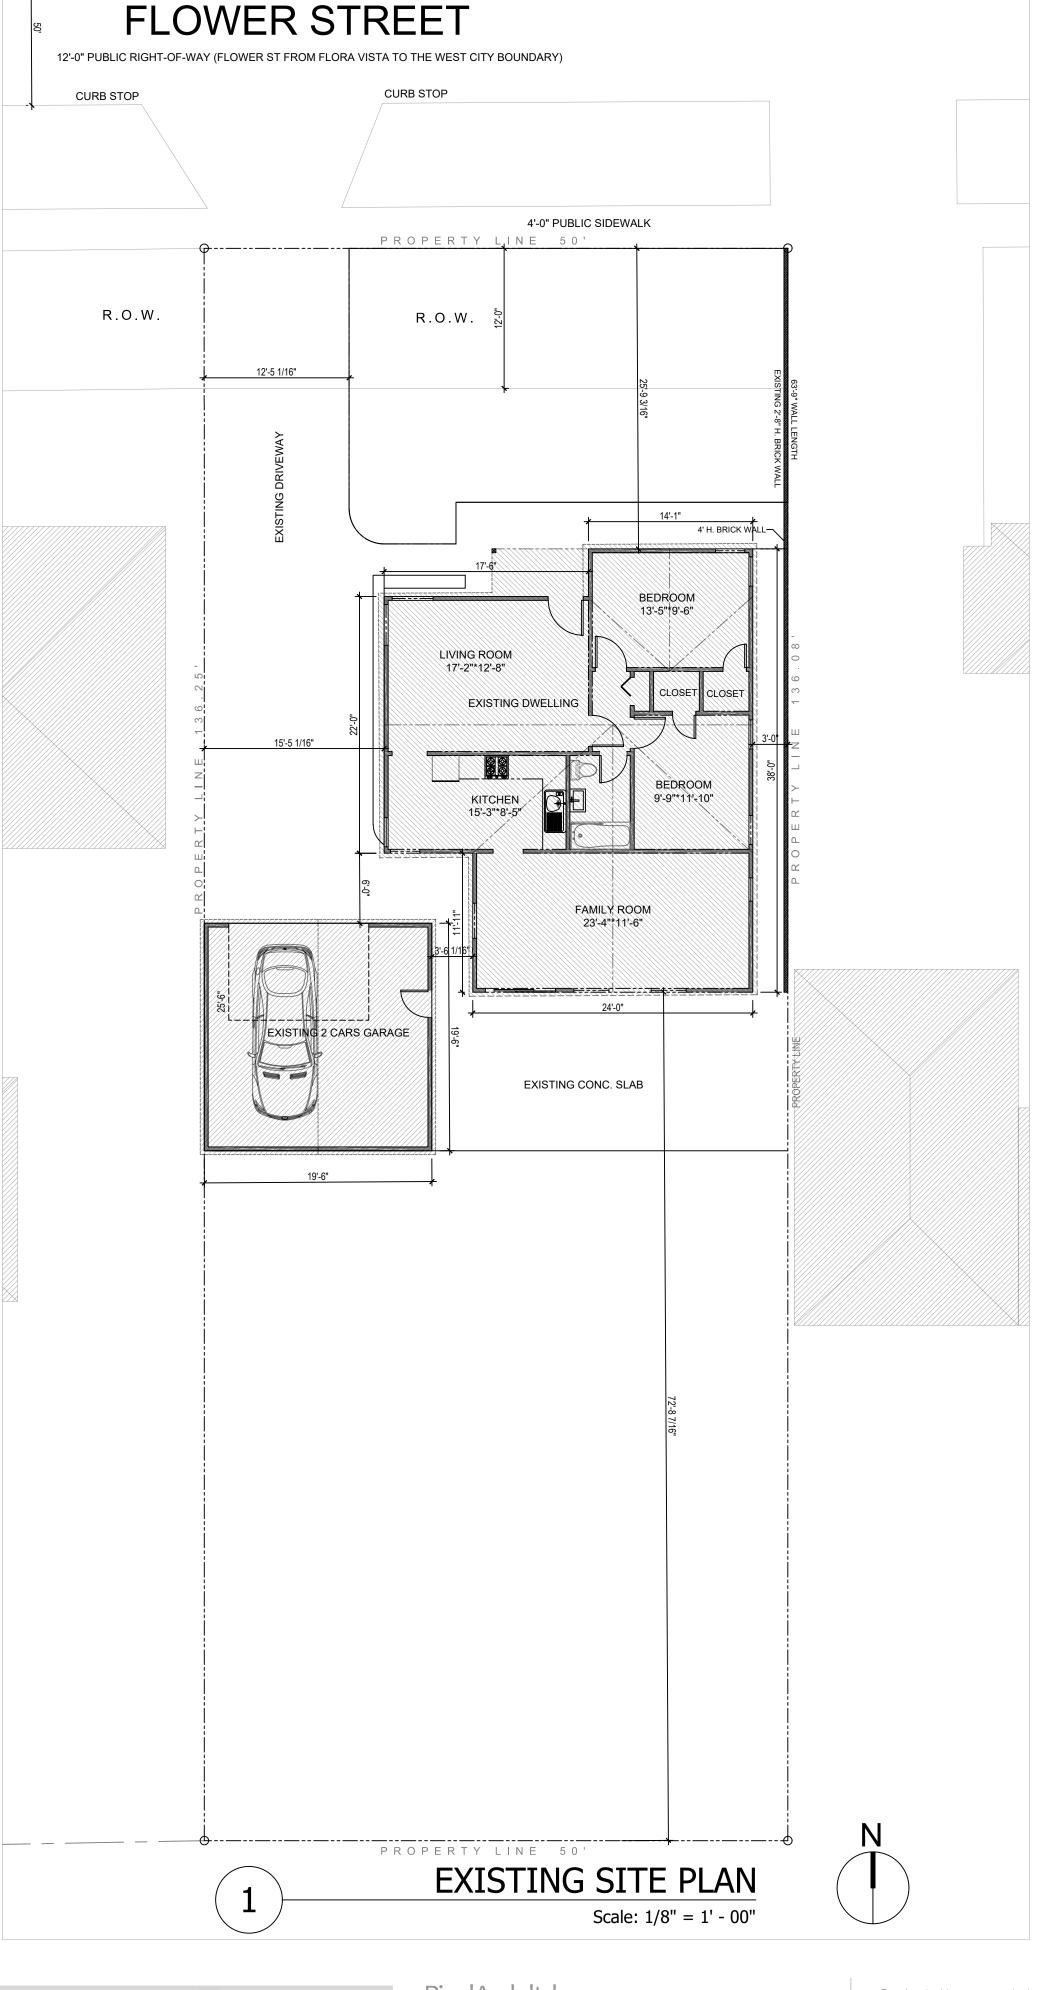
DRAWING INDEX:

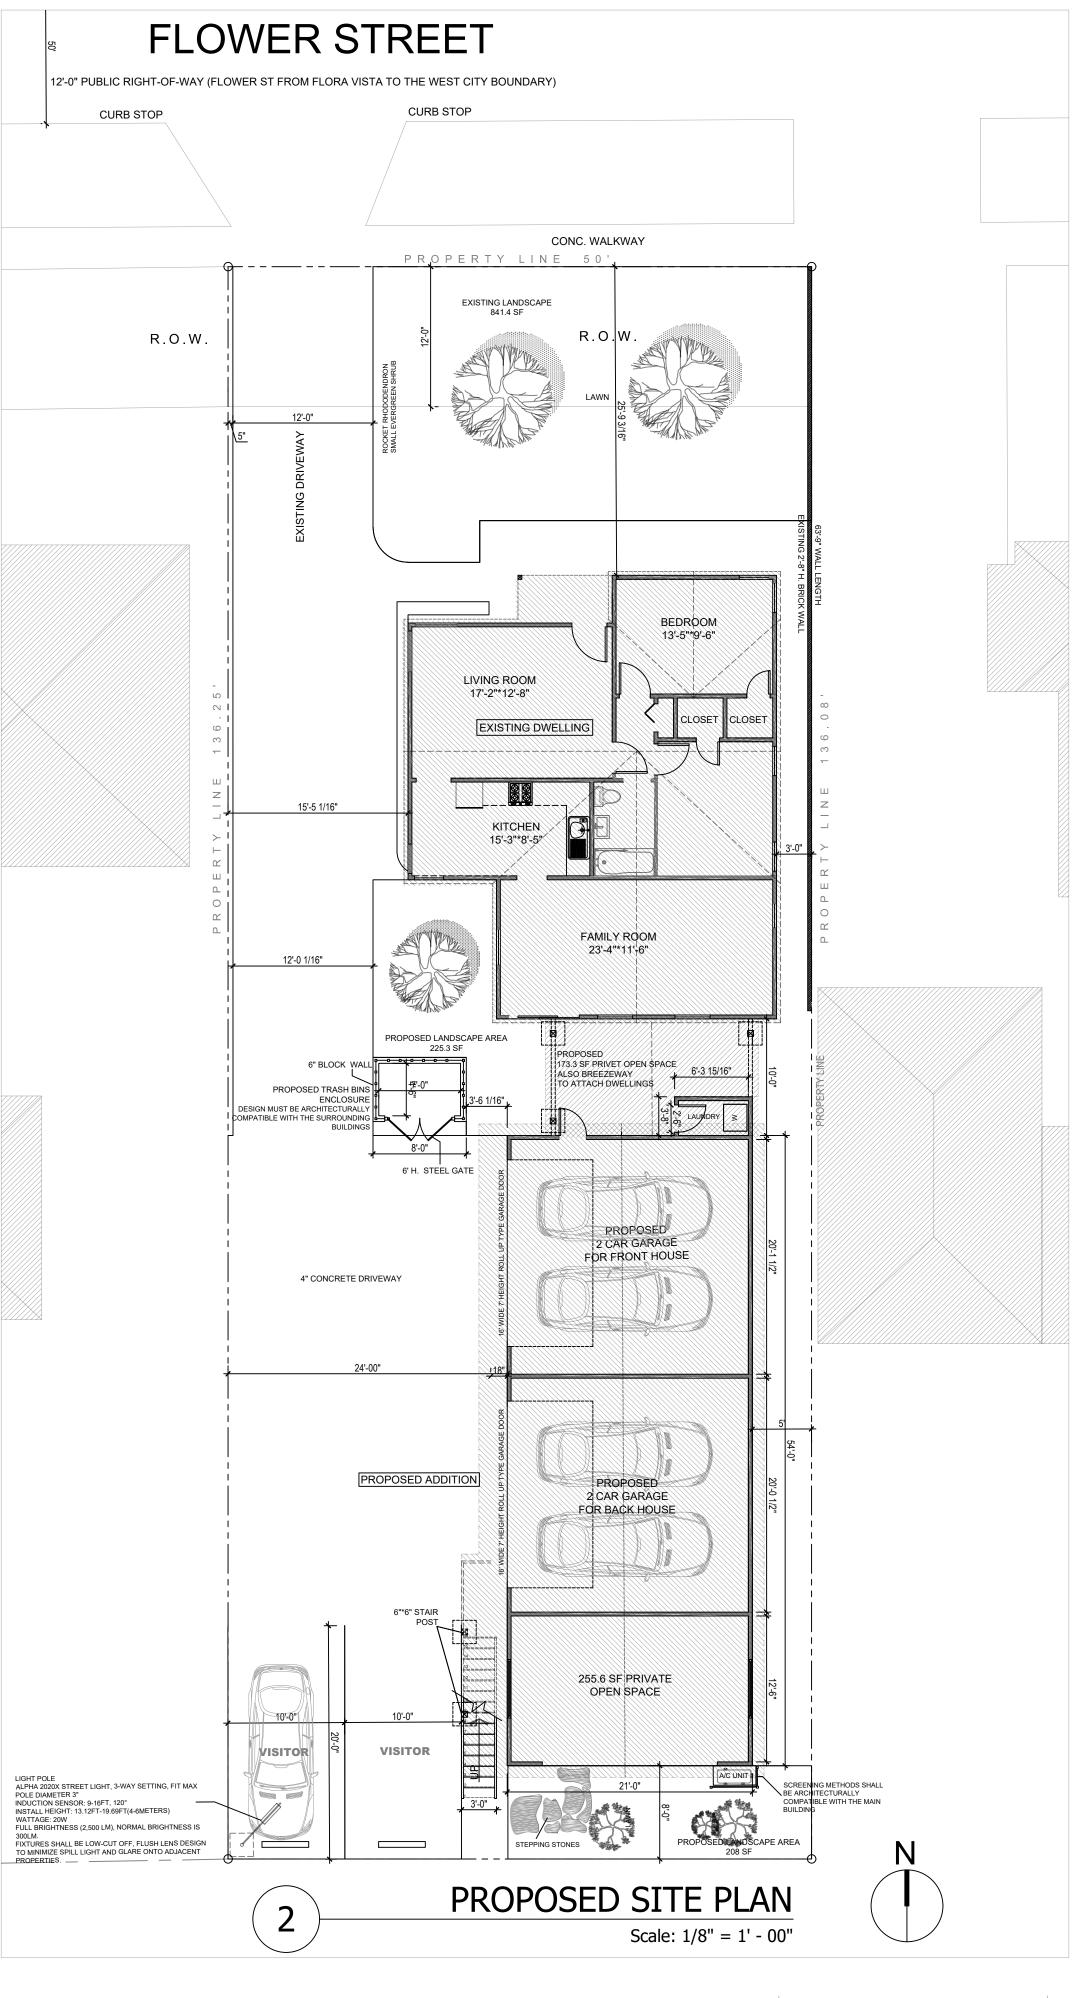
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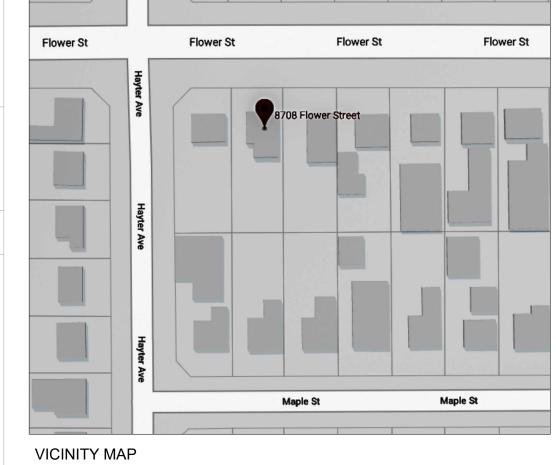



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REVISION TABLE
DATE REVISED BY DESCRIPTION







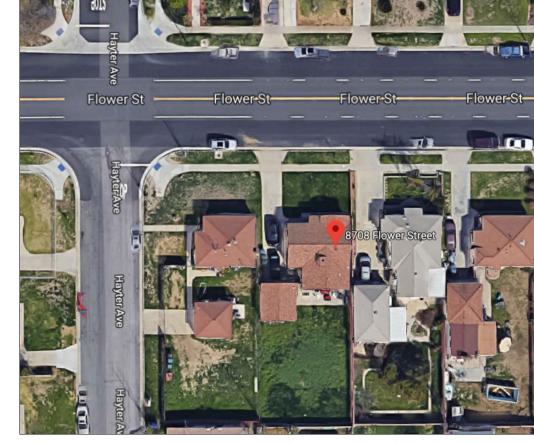

AERIAL PHOTO

SCOPE OF WORK:

DEMOLISH EXISTING 2 CAR GARAGE, BUILD NEW 2 BEDROOM 2 BATH HOME OVER NEW 4 CAR GARAGE WITH COVERED PATIO AND ATTACH TO EXISTING 2 BED 1 BATH HOME WITH BREEZEWAY, POUR NEW CONCRETE DRIVEWAY AND INSTALL NEW LANDSCAPE.

PROPERTY ADDRESS:

8708 FLOWER ST, BELLFLOWER, CA, 90706

LEGAL DESCRIPTION:

LOT 24, BLOCK 79 OF FLOWER ST, CITY OF BELLFLOWER, CALIFORNIA. TRACT NO. 12736 M.B. 243-17-18

ZONING CLASSIFICATION:

(TITLE 17 ZONING): R 2-MEDIUM DENSITY RESIDENTIAL ZONE

APN (7107,008,024)

OCCUPANCY GROUP:

R (RESIDENTIAL)

PARKING SPACES REQUIRED: 4 VISITORS: 2 TOTAL: 6

PARKING SPACES PROVIDED: 4 VISITORS: 2 TOTAL: 6

OWNER: GILBERT SCALES PHONE:

CURRENT LIVING SQUARE FOOTAGE:

1449.7 SQ. FT UNDER ROOF

CONTACT INFORMATION:

1041 SQ. FT LIVING AREA

380.2 SQ. FT GARAGE

28.5 SQ. FT COVERED FRONT PORCH

LOT SIZE: 136'-5"*50' = 6825 SF

EXISTING LANDSCAPING AREA: 841.4 SF

PROPOSED ADDITIONAL LANDSCAPING AREA: 433.3SF

PROPOSED LIVING SQUARE FOOTAGE:

3564.6 SQ. FT UNDER ROOF

2242.8 SQ. FT LIVING AREA (1041 SQ. FT 1ST FLOOR; 1201.8 SQ. FT 2ND FLOOR)

864.4 SQ. FT 4 CAR GARAGES

SQ. FT COVERED FRONT PORCH

SQ. FT BREEZEWAYS & PRIVATE OPEN SPACE

IMPERVIOUS SURFACE:

DWELLING = 2242.8 SFGARAGE = 864.4 SF

PORCH = 28.5 SF

DRIVEWAY/WALKS/PARKING SPACES = 2679.5 SF

LOT COVERAGE = 2242.8/6825 = 32.8%

GENERAL NOTES:

THE GENERAL CONTRACTOR SHALL FULLY COMPLY WITH THE FOLLOWING INTERNATIONAL CODES, 2016 CALIFORNIA BUILDING

STANDARDS CODE (CAL. CODE REGS., TITLE 24) COMPLIANCE WITH CITY OF BELLFLOWER REGULATIONS AND ORDINANCES.

CALGREEN CALIFORNIA GREEN BUILDING STANDARDS CODE (CALGREEN), PART 11 OF TITLE 24

CBC CALIFORNIA BUILDING CODE (PART 2 OF TITLE 24) CCR CALIFORNIA CODE OF REGULATIONS

CEBC CALIFORNIA EXISTING BUILDING CODE (PART 10 OF TITLE 24)

CEC CALIFORNIA ELECTRICAL CODE (PART 3 OF TITLE 24)

CEC CALIFORNIA ENERGY CODE (PART 6 OF TITLE 24)

CEC CALIFORNIA ENERGY COMMISSION CMC CALIFORNIA MECHANICAL CODE (PART 4 OF TITLE 24)

CPC CALIFORNIA PLUMBING CODE (PART 5 OF TITLE 24)

CRSC CALIFORNIA REFERENCED STANDARDS CODE (PART 12

DPH IDENTIFIES CODE PROVISIONS BY THE DEPARTMENT OF PUBLIC HEALTH IBC INTERNATIONAL BUILDING CODE

OF TITLE 24)

IFC INTERNATIONAL FIRE CODE

IEBC INTERNATIONAL EXISTING BUILDING CODE IRC INTERNATIONAL RESIDENTIAL CODE

NEC NATIONAL ELECTRICAL CODE

NFPA NATIONAL FIRE PROTECTION ASSOCIATION

DESIGN HAS BEEN DONE PRESCRIPTIVELY TO THE 2016CALIFORNIA BUILDING CODES



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Project Name and Address:

PROPOSED ADDITION FOR

GILBERT SCALES

8708 FLOWER ST, BELLFLOWER, CA, 90706

DRAWING TITLE:

EXISTING AND PROPOSED FLOOR PLANS

APRIL 26, 2018

Date Revision/Issue Preliminary plan review January 19, 2018 submittal

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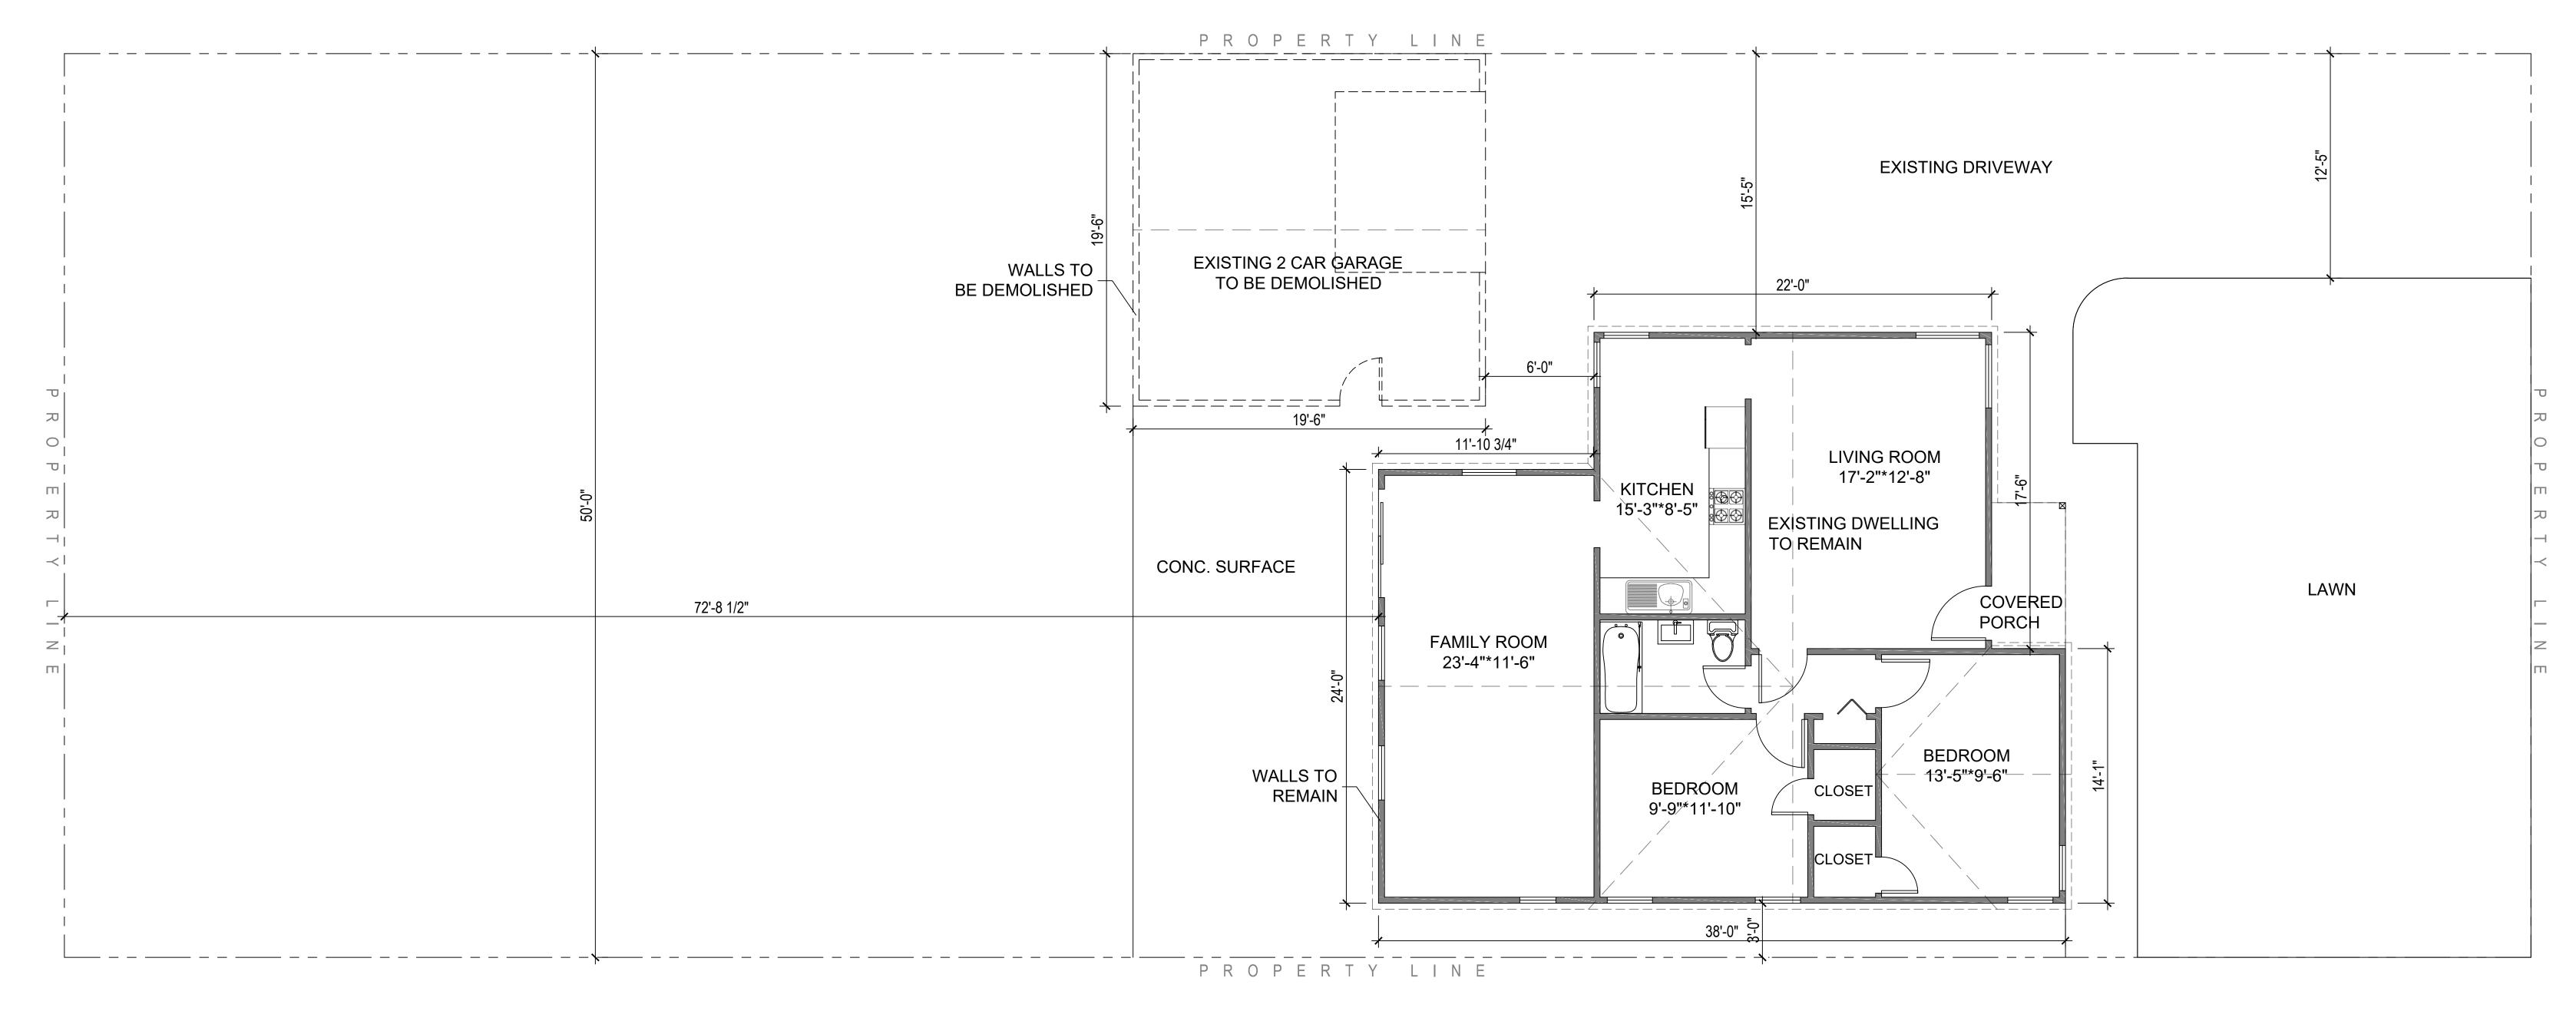
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1 of



DEMOLISHE PLAN

Scale: 1/4" = 1' - 00"

GENERAL DEMOLITION NOTES

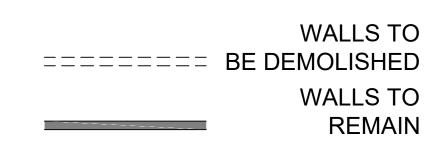
- 1 , ALL HATCHED WALLS, DOORS, AND WINDOWS ARE TO BE REMOVED.
- 2 CONTRACTOR TO INSTALL TEMPORARY SHORING AS REQ'D. TO SUPPORT STRUCTURE UNTIL NEW PERMANENT SUPPORT IS IN PLACE.

GENERAL RENOVATION NOTES

- 1 CONTRACTORS TO VERIFY ALL EXISTING CONDITIONS PRIOR TO BIDDING AND CONSTRUCTION.
- 2 , ALL NEW INTERIOR WALLS TO BE 2x4 STUDS ($3\ 1/2$ ") fa 16" O.C. W/In" GYP. BRD. , USE MOISTURE RESISTANT GYP. BRD. e PLUMBING FIXTURES.
- 3 , ALL AREAS DISTURBED BY CONSTRUCTION WHICH ARE TO REMAIN UNTOUCHED ARE TO BE RETURNED TO ORIGINAL CONDITION.

FINISH NOTES

- 3 , FLOORING TO BE INSTALLED IN FINISH AREAS (PER OWNER)
- 4 ALL FINISH SELECTIONS PER OWNER



GENERAL NOTES:

THE BUILDER SHALL VERIFY THAT SITE CONDITIONS ARE CONSISTENT WITH THESE PLANS BEFORE STARTING WORK .WORK NOT SPECIFICALLY DETAILED SHALL BE CONSTRUCTED TO THE SAME QUALITY AS SIMILAR WORK THAT IS DETAILED .ALL WORK SHALL BE DONE IN ACCORDANCE WITH INTERNATIONAL BUILDING CODES AND LOCAL CODES.

WRITTEN DIMENSIONS AND SPECIFIC NOTES SHALL TAKE PRECEDENCE OVER SCALED DIMENSIONS AND GENERAL NOTES .THE ENGINEER/DESIGNER SHALL BE CONSULTED FOR CLARIFICATION IF SITE CONDITIONS ARE ENCOUNTERED THAT ARE DIFFERENT THAN SHOWN, IF DISCREPANCIES ARE FOUND IN THE PLANS OR NOTES, OR IF A QUESTION ARISES OVER THE INTENT OF THE PLANS OR NOTES. CONTRACTOR SHALL VERIFY AND IS RESPONSIBLE FOR ALL DIMENSIONS (INCLUDING ROUGH OPENINGS).

PLEASE SEE ADDITIONAL NOTES CALLED OUT ON OTHER SHEETS.

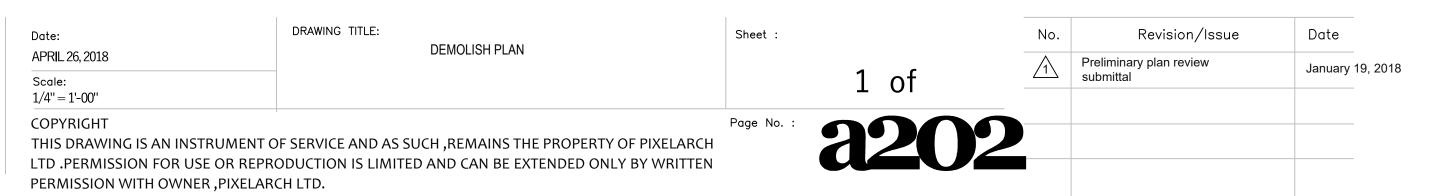
BUILDING PERFORMANCE:

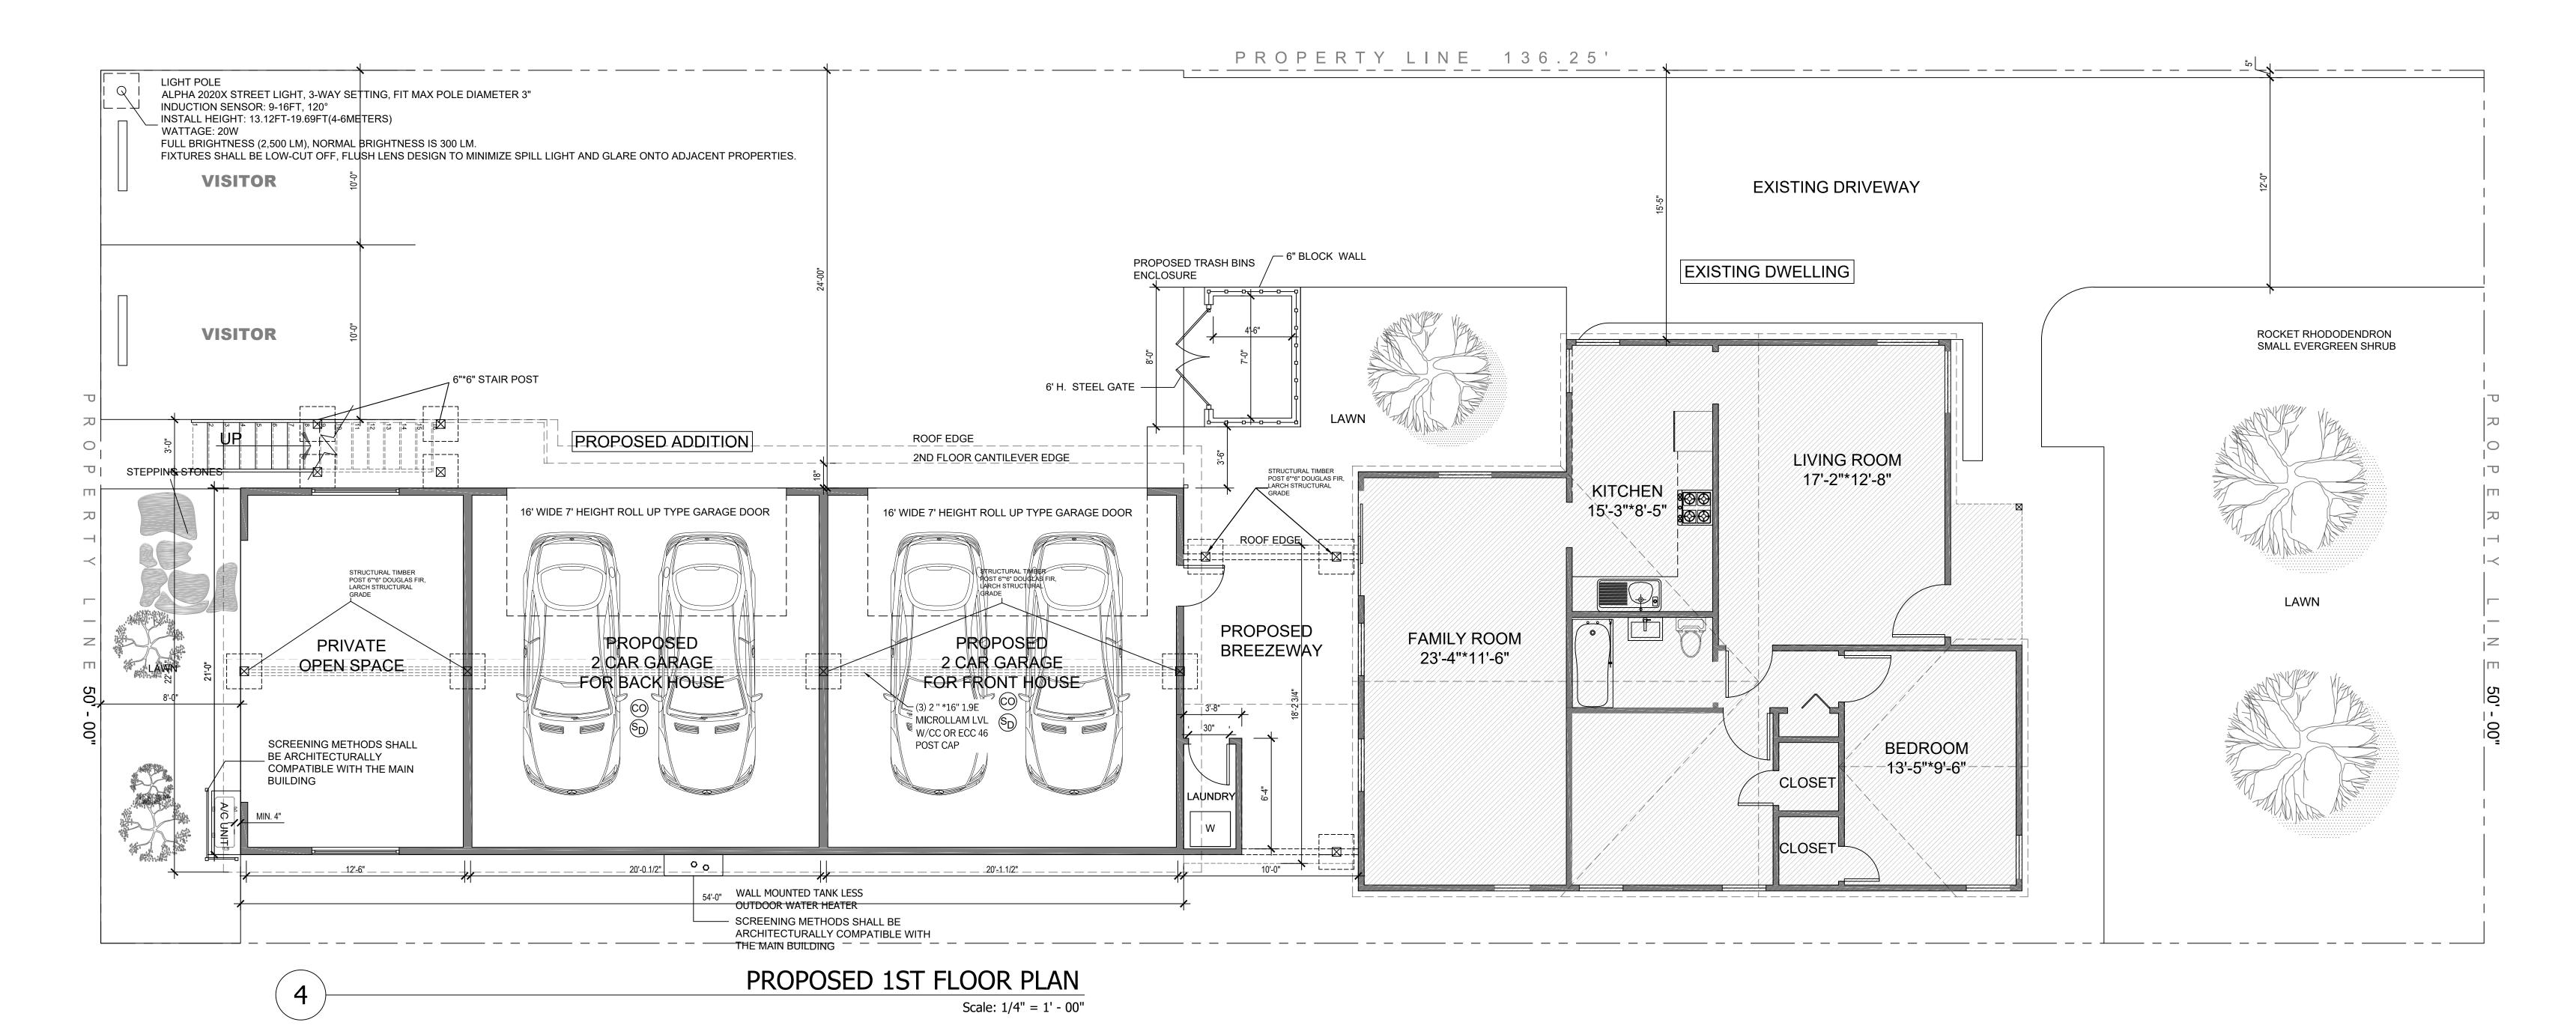
HEAT LOSS CALCULATIONS SHALL COMPLY WITH THE REQUIREMENTS OF REGIONAL AND LOCAL CODES .SEE CALCULATIONS .PORCHES ,DECKS ,FOUNDATION ,FIREPLACE ENCLOSURES , AND GARAGE AREAS NOT INCLUDED IN LIVING AREA .ALL EXHAUST FANS TO BE VENTED DIRECTLY TO THE EXTERIOR .ALL PENETRATIONS OF THE BUILDING ENVELOPE SHALL BE SEALED WITH CAULK OR FOAM .



Project Name and Address:

GILBERT SCALES
8708 FLOWER ST, BELLFLOWER, CA, 90706





GENERAL NOTES AND SPECIFICATIONS

THE GENERAL CONTRACTOR SHALL FULLY COMPLY WITH THE 2016 IBC AND ALL ADDITIONAL STATE AND LOCAL CODE REQUIREMENTS. 2016 IEC AND 2016 IMC SHALL BE USED.

THE CONTRACTOR SHALL ASSUME FULL RESPONSIBILITY FOR ANY WORK KNOWINGLY PERFORMED CONTRARY TO SUCH LAWS, ORDINANCES, OR REGULATIONS. THE CONTRACTOR SHALL ALSO PERFORM COORDINATION WITH ALL UTILITIES AND STATE SERVICE AUTHORITIES.

THE GENERAL CONTRACTOR IS RESPONSIBLE FOR THE DESIGN AND PROPER FUNCTION OF PLUMBING, HVAC AND ELECTRICAL SYSTEMS. THE GENERAL CONTRACTOR SHALL NOTIFY THIS OFFICE WITH ANY PLAN CHANGES REQUIRED FOR DESIGN AND FUNCTION OF PLUMBING, HVAC AND ELECTRICAL SYSTEMS.

THIS OFFICE SHALL NOT BE RESPONSIBLE FOR CONSTRUCTION MEANS AND METHODS, ACTS OR OMISSIONS OF THE CONTRACTOR OR SUBCONTRACTOR, OR FAILURE OF ANY OF THEM TO CARRY OUT WORK IN ACCORDANCE WITH THE CONSTRUCTION DOCUMENTS. AND DEFECT DISCOVERED IN THE CONSTRUCTION DOCUMENTS SHALL BE BROUGHT TO THE ATTENTION OF THIS OFFICE BY WRITTEN NOTICE BEFORE PROCEEDING WITH WORK. REASONABLE TIME NOT ALLOWED THIS OFFICE TO CORRECT THE DEFECT SHALL PLACE THE BURDEN OF COST AND LIABILITY FROM SUCH DEFECT UPON THE CONTRACTOR.

DESIGN CRITERIA: 2016 IRC AND IBC

ROOF: 50 PSF SNOW LOAD

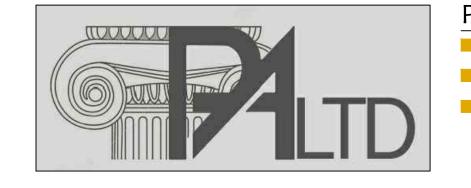
*8 PSF TOP CHORD DL.

*7 PSF BOTTOM CHORD DL.

*5 PSF NET WIND UPLIFT.

FLOOR: 40 PSF LL.

*10 PSF TOP CHORD DL.



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*5 PSF BOTTOM CHORD DL.

SOIL: *2,000 PSF ALLOWABLE (ASSUMED). TO BE AT TIME OF EXCAVATION

FROST DEPTH: *2'-0" SEISMIC ZONE: C,

WIND: 90 MPH (90 MPH 3 SEC GUST), EXPOSURE C.

THIS STRUCTURE SHALL BE ADEQUATELY BRACED FOR WIND LOADS UNTIL THE ROOF, FLOOR AND WALLS HAVE BEEN PERMANENTLY FRAMED TOGETHER AND SHEATHED.

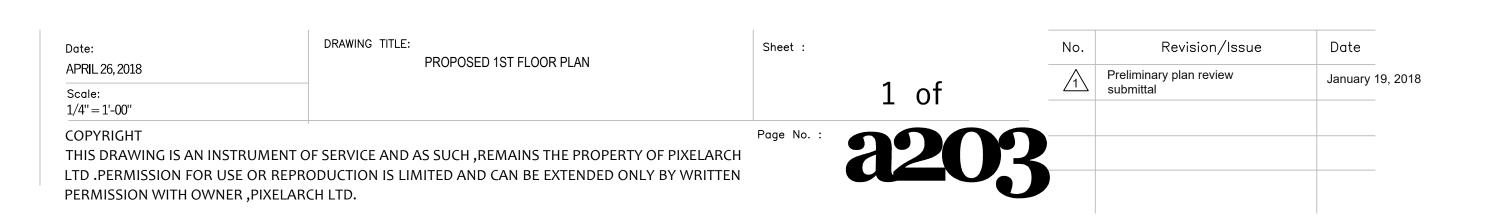
INSTALL POLYISOCYANURATE FOAM TYPE INSULATION AT FLOOR AND PLATE LINES, OPENINGS IN PLATES, CORNER STUD CAVITIES AND AROUND DOOR AND WINDOW ROUGH OPENING CAVITIES.

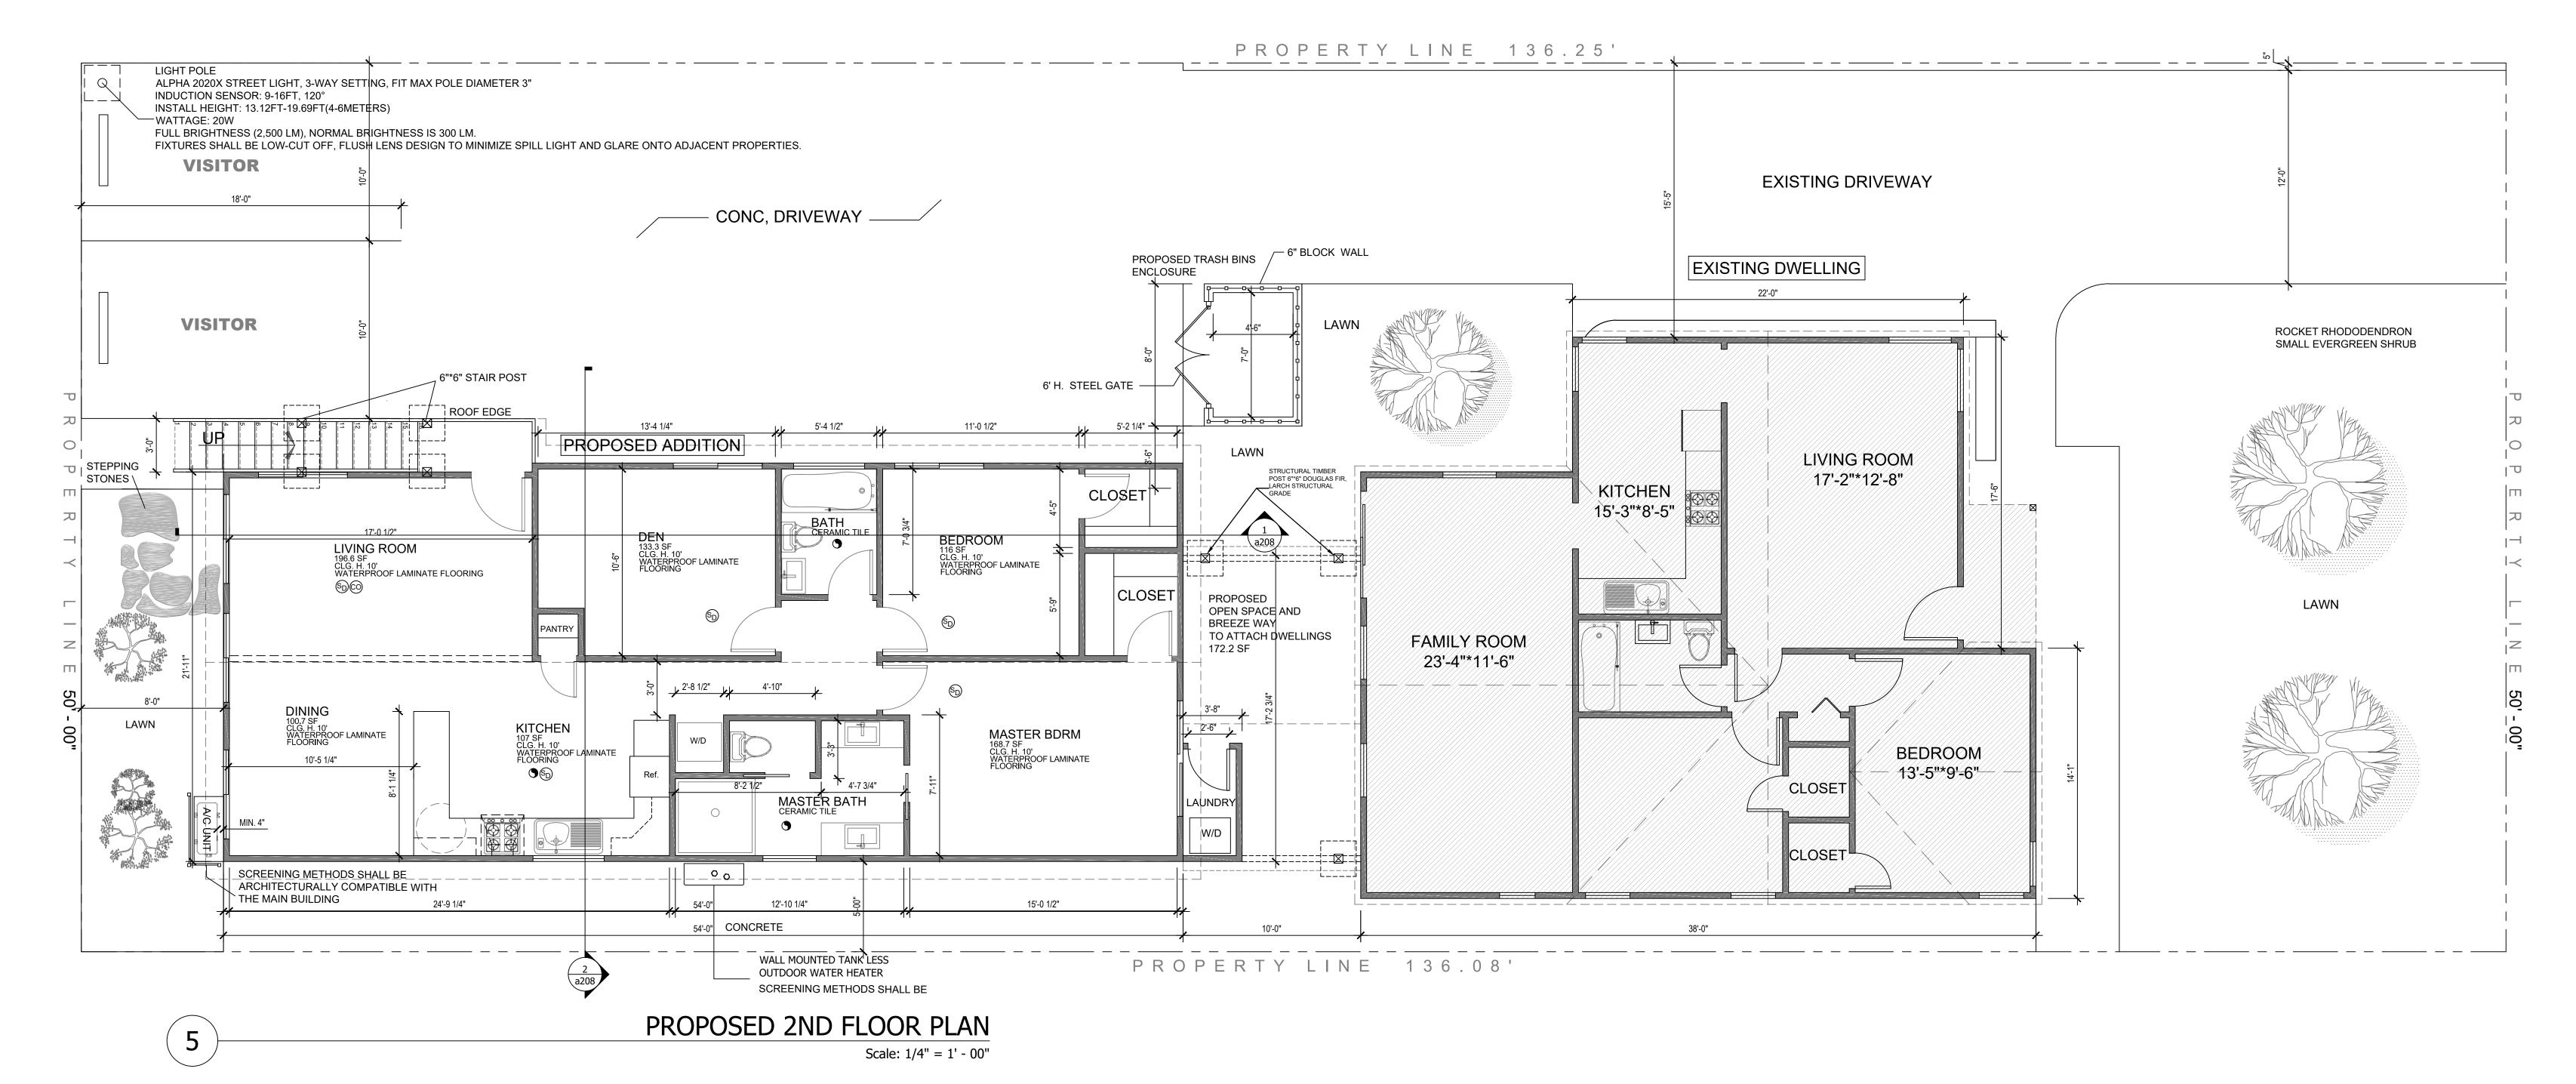
INSTALL WATERPROOF GYPSUM BOARD AT ALL WATER SPLASH AREAS TO MINIMUM 70" ABOVE SHOWER DRAINS. INSULATE WASTE LINES FOR SOUND CONTROL.

EXHAUST ALL VENTS AND FANS DIRECTLY TO OUTSIDE VIA METAL DUCTS, PROVIDE 90 CFM (MIN) FANS TO PROVIDE 5 AIR CHANGES PER HOUR IN BATHS CONTAINING TUB AND / OR SHOWER AND IN LAUNDRY ROOMS.

ALL RECESSED LIGHTS IN INSULATED CEILINGS TO HAVE THE I.C. LABEL.

PROVIDE SOLID BLOCKING UNDER ALL BEARING WALLS PERPENDICULAR TO JOISTS AND OTHER BEARING POINTS NOT OTHERWISE PROVIDED WITH SUPPORT.





CARPENTRY:

SAWN LUMBER DESIGN IS BASED ON THE NATIONAL DESIGN SPECIFICATION, LATEST EDITION. SAWN LUMBER SHALL CONFORM TO WEST COAST LUMBER INSPECTION BUREAU OR WESTERN WOOD PRODUCTS ASSOCIATION GRADING RULES. ALL LUMBER NOT SPECIFICALLY NOTED TO BE D.F. #2 OR BETTER. ALL WOOD IN PERMANENT CONTACT WITH CONCRETE OR CMU SHALL BE PRESSURE TREATED UNLESS AN APPROVED BARRIER IS PROVIDED. FRAMING ACCESSORIES AND STRUCTURAL FASTENERS SHALL BE MANUFACTURED BY SIMPSON STRONG-TIE COMPANY (OR ENGINEER APPROVED EQUAL) AND OF THE SIZE AND TYPE SHOWN ON THE DRAWINGS. HANGERS NOT SHOWN SHALL BE SIMPSON HU OF SIZE RECOMMENDED FOR MEMBER. ALL HANGERS AND NAILS IN CONTACT WITH PRESSURE TREATED LUMBER SHALL BE SIMPSON Z-MAX HANGERS OR STAINLESS STEEL. ALL SHEAR WALL SHEATHING NAILS SHALL BE COMMON NAILS SHALL BE COMMON NAILS OR HOT DIPPED GALVANIZED BOX NAILS. FRAMING NAILS SHALL BE PER IBC TABLE 2304.9.1 OR IRC TABLE R602.3(1).

PLYWOOD PANELS SHALL CONFORM TO THE REQUIREMENTS OF "U.S. PRODUCT STANDARD PS 1 FOR CONSTRUCTION AND INDUSTRIAL PLYWOOD" OR APA PRP-108 PERFORMANCE STANDARDS. UNLESS NOTED, PANELS SHALL BE APA RATED SHEATHING, EXPOSURE 1, OF THE THICKNESS AND SPAN RATING SHOWN ON THE DRAWINGS. PLYWOOD INSTALLATION SHALL BE IN CONFORMANCE WITH APA RECOMMENDATIONS. ALLOW 1/8" SPACING AT PANELS ENDS AND EDGES, UNLESS OTHERWISE RECOMMENDED BY THE PANEL MANUFACTURER.

ALL ROOF SHEATHING AND SUB-FLOORING SHALL BE INSTALLED WITH FACE GRAIN PERPENDICULAR TO SUPPORTS, EXCEPT AS INDICATED ON THE DRAWINGS. ROOF SHEATHING SHALL EITHER BE BLOCKED, TONGUE-AND-GROOVE, OR HAVE EDGES SUPPORTED BY PLYCLIPS. SHEAR WALL SHEATHING SHALL BE BLOCKED WITH 2X FRAMING AT ALL PANEL EDGES. NAILING NOT SPECIFICALLY IDENTIFIED ON THE DRAWINGS TO CONFORM WITH IRC TABLE R602.3(1).

GLUED LAMINATED MEMBERS SHALL BE FABRICATED IN CONFORMANCE WITH U.S. PRODUCT STANDARD PS 56, "STRUCTURAL GLUED LAMINATED TIMBER" AND AMERICAN INSTITUTE OF TIMBER CONSTRUCTION, AITC 117. EACH MEMBER SHALL BEAR AN AITC OR APA-EWS IDENTIFICATION MARK AND BE ACCOMPANIED BY A CERTIFICATE OF CONFORMANCE. ONE COAT OF END SEALER SHALL BE APPLIED IMMEDIATELY AFTER TRIMMING IN EITHER SHOP OR FIELD. GLULAM HANGERS NOT SHOWN SHALL BE SIMPSON EG. BEAMS SHALL BE VISUALLY GRADED WESTERN SPECIES INDUSTRIAL GRADE, AND OF THE STRENGTH INDICATED BELOW:



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COMBINATION
SYMBOL SPECIES USE
24F - V4 DF/DF (SIMPLE SPAN)

DF/DF

PREMANUFACTURED WOOD JOISTS: PREMANUFACTURED WOOD JOISTS SHALL BE OF THE SIZE AND TYPE SHOWN ON THE DRAWINGS, MANUFACTURED BY THE TRUS JOIST COMPANY, OR AN ENGINEER APPROVED EQUAL. PROVIDE BRIDGING IN CONFORMANCE WITH THE MANUFACTURERS RECOMMENDATIONS. JOISTS AND BRIDGING SHALL BE CAPABLE OF RESISTING THE WIND UPLIFT NOTED ON THE DRAWINGS. THE JOIST MANUFACTURER SHALL VISIT JOB SITE AS REQUIRED AND VERIFY THE PROPER INSTALLATION OF JOISTS IN WRITING TO THE ARCHITECT/ENGINEER. PREMANUFACTURED WOOD JOIST ALTERNATES WILL BE CONSIDERED, PROVIDED THE ALTERNATE IS COMPATIBLE WITH THE LOAD CAPACITY, STIFFNESS, DIMENSIONAL, AND FIRE RATING REQUIREMENTS OF THE PROJECT. AND IS ICBO APPROVED.

(CONT. OR CANTILEVER)


LUMBER SPECIES:


- A. POSTS, BEAMS, HEADERS, JOISTS, AND RAFTERS TO BE DF-#2
- B. EXPOSED ARCH BEAMS TO BE DF-#1 OR BETTER
- C. SILLS, PLATES BLOCKING, AND BRIDGING TO BE DF-#2.
- D. ALL STUDS TO BE DF#2 OR BETTER.

24F - V8


- E. PLYWOOD SHEATHING SHALL BE AS FOLLOWS:
- ROOF SHEATHING SHALL BE 1/2" CDX INT-APA RATED 32/16.
 WALL SHEATHING SHALL BE 1/2" INT-APA RATED 32/16 OR 7/16" OSB.
 FLOOR SHEATHING SHALL BE 3/4" T & G INT-APA RATED OSB.
- F. 'I'JOISTS SHALL BE MANUFACTURED BY TRUS JOIST OR ENGINEER APPROVED EQUAL.
- G. ALL WOOD IN CONTACT WITH CONCRETE SHALL BE PRESSURE TREATED.

Date: APRIL 26, 2018 Scale: 1/4"=1'-0"	DRAWING TITLE: PROPOSED 2ND FLOOR PLAN	Sheet :	1 of	No.	Revision/Issue Preliminary plan review submittal	Date January 19, 2018
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PROPOSED SOUTH ELEVATION

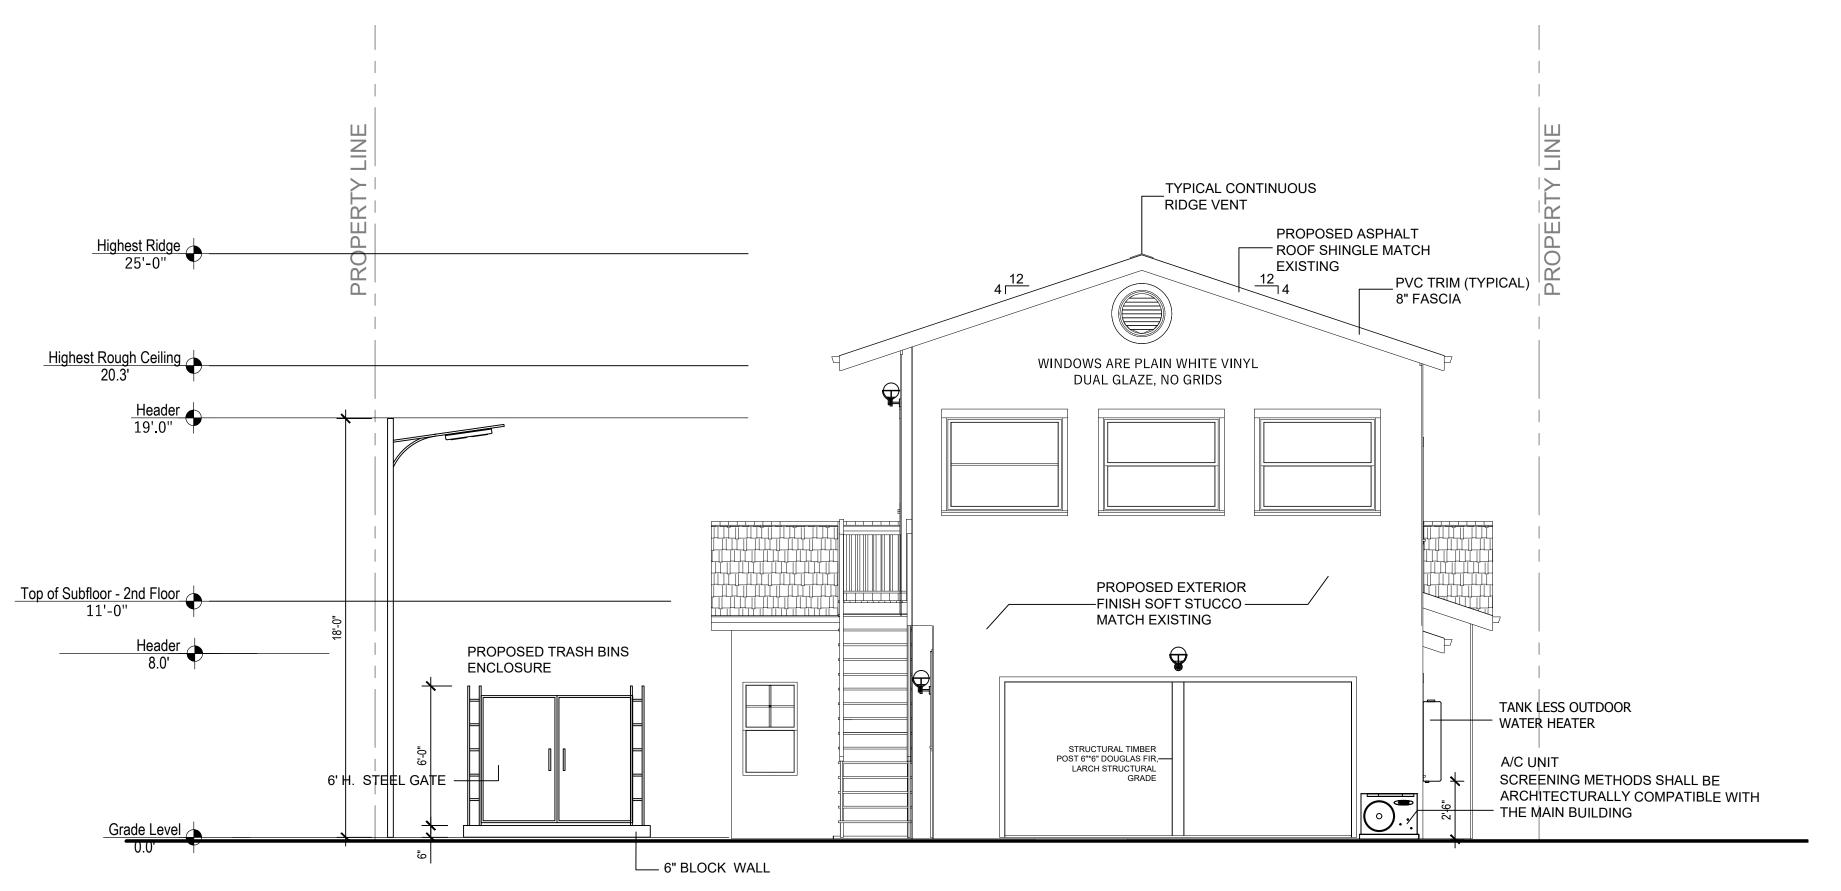

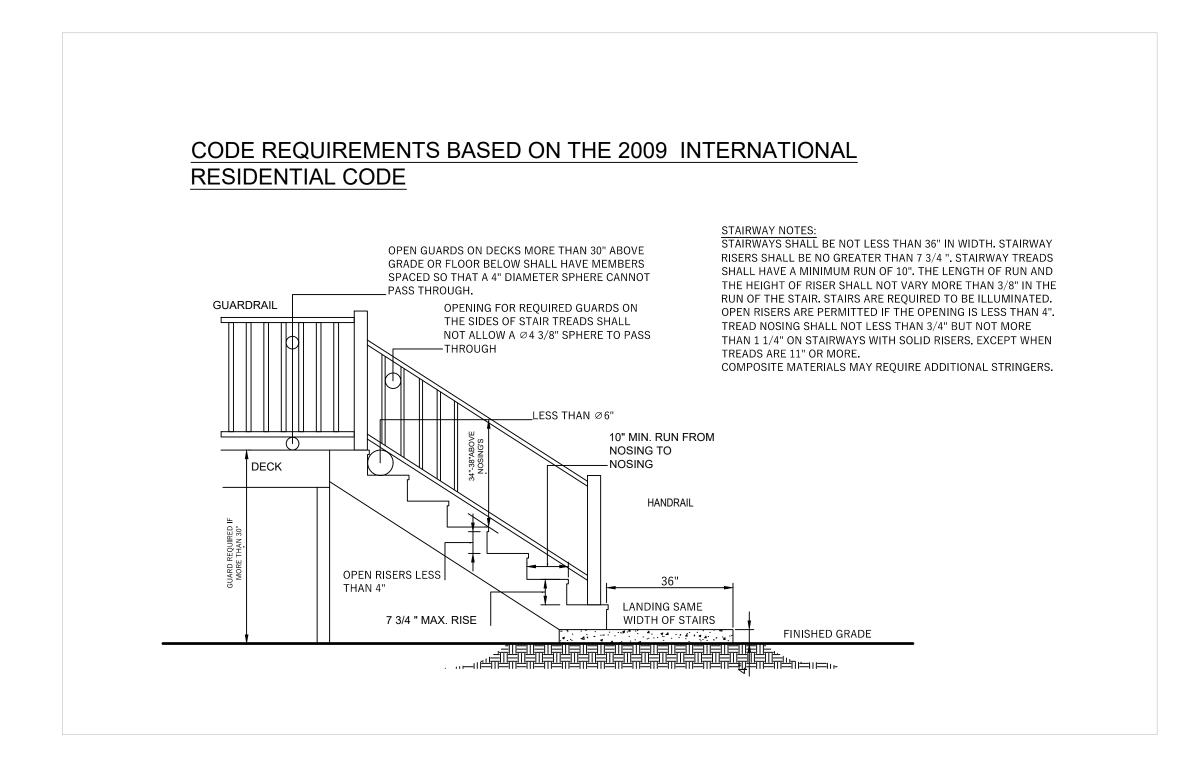Scale: 1/4'' = 1' - 00''

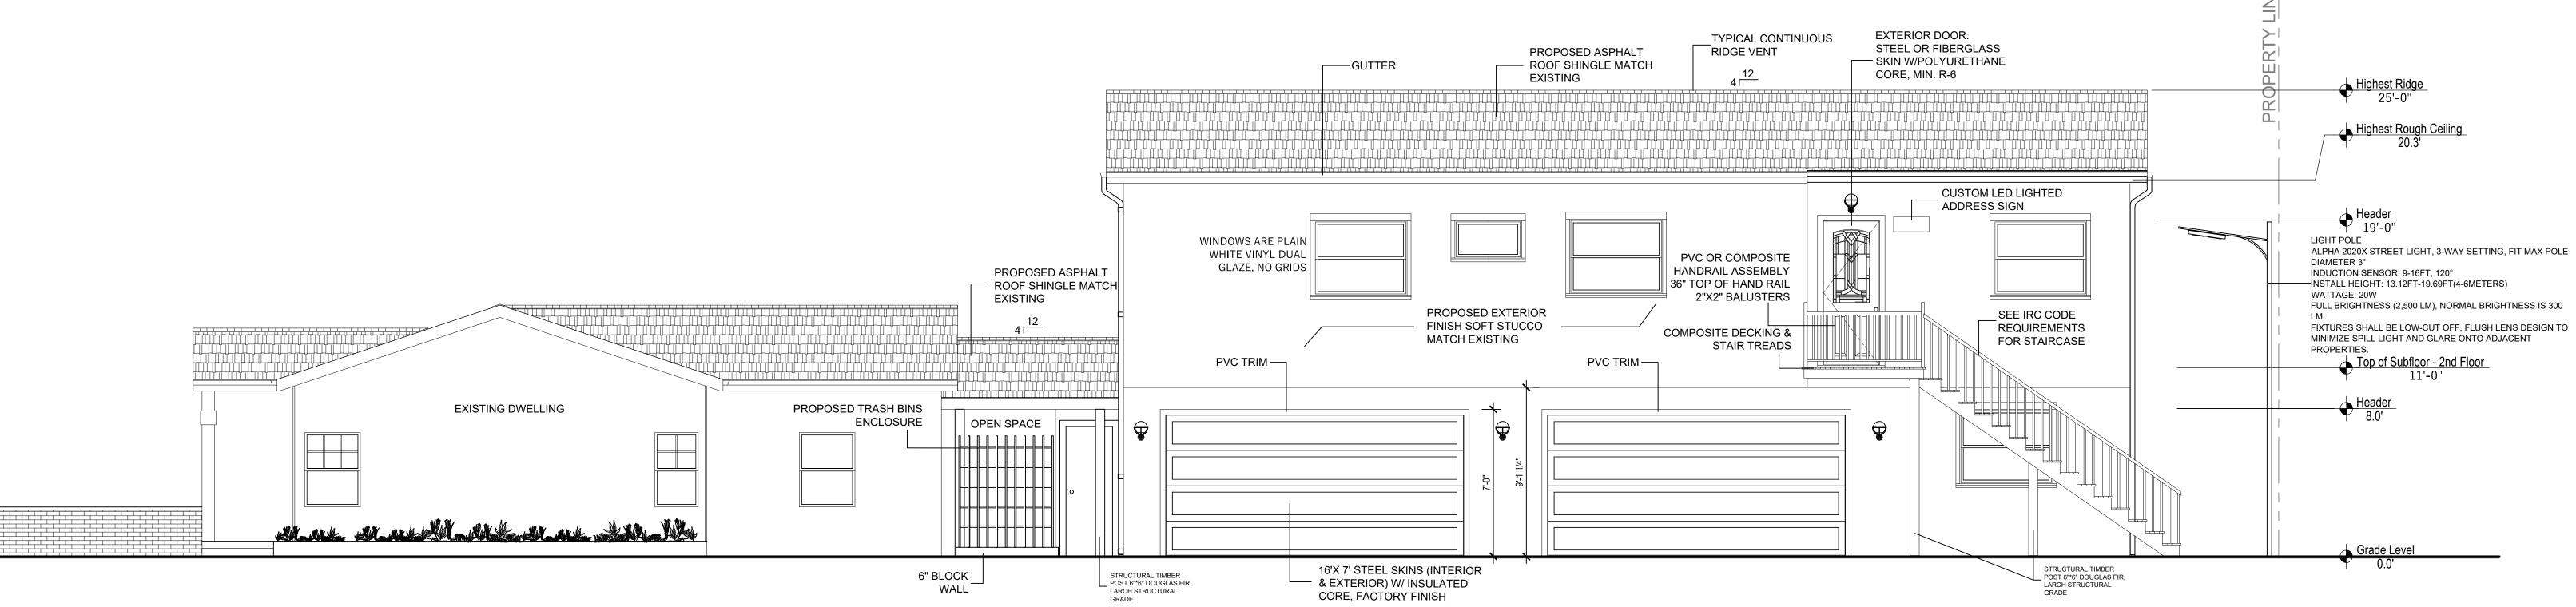PROPOSED EAST ELEVATION

Scale: 1/4" = 1' - 00"




Project Name and Address:

PROPOSED ADDITION FOR

GILBERT SCALES


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Date: APRIL 26, 2018	DRAWING TITLE: PROPOSED ELEVATIONS	Sheet :			No.	Revision/Issue	Date
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PROPOSED NORTH ELEVATION

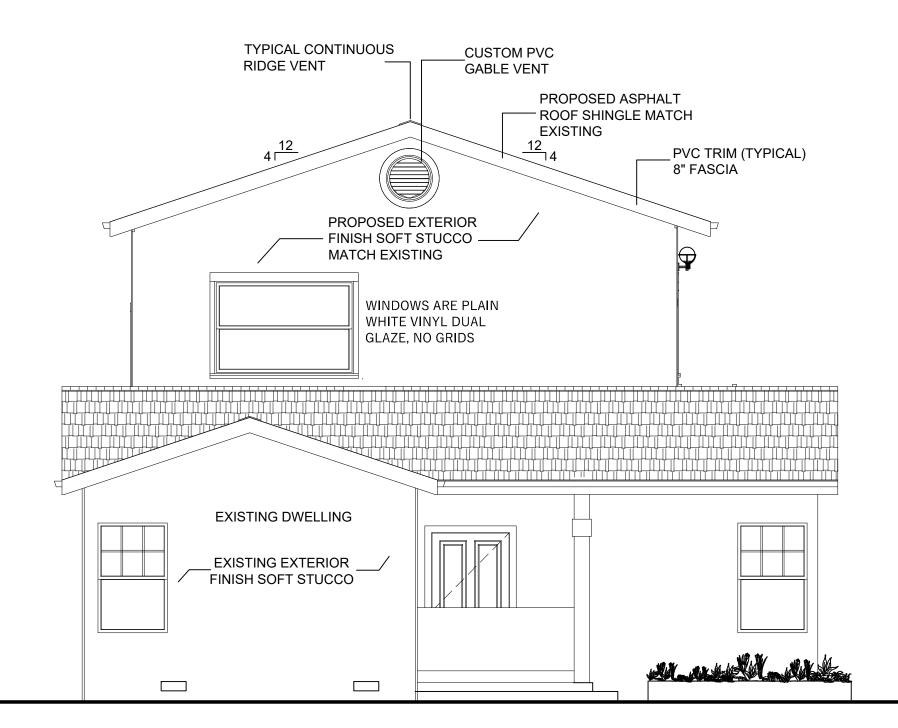Scale: 1/4" = 1' - 00"



PROPOSED WEST ELEVATION

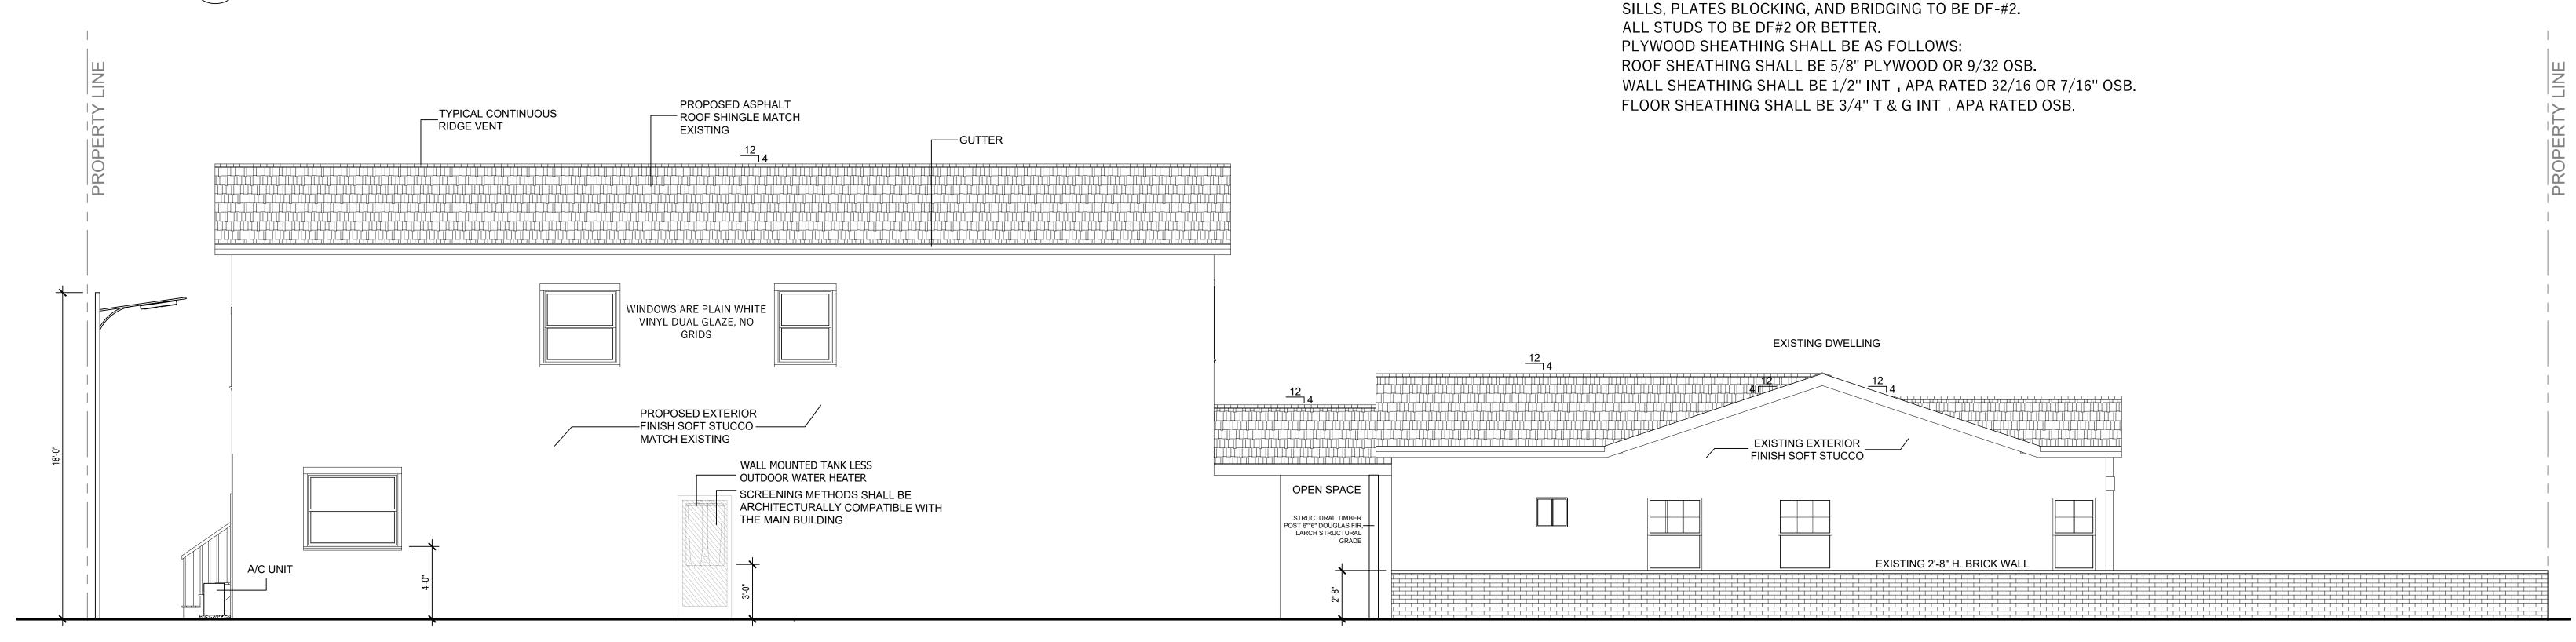
Scale: 1/4" = 1' - 00"



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GILBERT SCALES

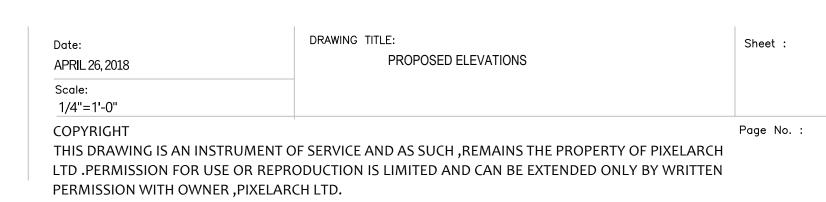8708 FLOWER ST, BELLFLOWER, CA, 90706



EXTERIOR FINISH NOTES:

VENTILATION NOTES:

LUMBER SPECIES:

BE LOCATED TO PROVIDE CROSS VENTILATION.

SHALL BE LOCATED TO PROVIDE CROSS VENTILATION.

EXPOSED ARCH BEAMS TO BE DF-#1 OR BETTER.

POSTS, BEAMS, HEADERS, JOISTS, AND RAFTERS TO BE DF-#2.

MATERIAL AND COLOR BY OWNER.

EXTERIOR FINISH TO BE FIBER CEMENT SIDING OVER 5/8 CDX PLYWOOD/OSB. WINDOW & DOOR TRIM CEDAR.

ALL COMBUSTION APPLIANCES WILL BE VENTED DIRECTLY TO THE EXTERIOR. FURNACE FIREBOX AND TANKLESS

ATTIC SHALL HAVE VENTILATION EQUAL TO 1 SQ. FOOT PER 150 SQ. FEET OF ATTIC SPACE. VENTILATION SHALL BE PROTECTED FROM SNOW AND RAIN AND SHALL BE COVERED WITH GALVANIZED WIRE SCREEN. OPENINGS SHALL

WATER HEATER SHALL HAVE OUTSIDE COMBUSTION AIR SUPPLY PURSUANT TO REGIONAL AND LOCAL CODES.

EXHAUST ALL VENTS AND FANS DIRECTLY TO OUTSIDE VIA METAL DUCTS, PROVIDE 90 CFM (MIN) FANS TO

GARAGES SHALL BE VENTED WITH 60 SQUARE INCHES LOCATED 6" ABOVE THE FLOOR SURFACE.

PROVIDE 5 AIR CHANGES PER HOUR IN BATHS CONTAINING TUB AND / OR SHOWER AND IN LAUNDRY ROOMS.

UNDER FLOOR SPACES SHALL HAVE VENTILATION EQUAL TO ONE SQ. FOOT PER 150 SQ. FEET OF FLOOR SPACE.

VENTS SHALL BE CAST INTO THE CONCRETE STEM WALLS AND COVERED WITH GALVANIZED WIRE SCREEN. VENTS

DOWNSPOUTS TO BE COLLECTED AND ROOF RUN OFF TO BE DIRECTED AWAY FROM STRUCTURE PER THE SITE PLAN.

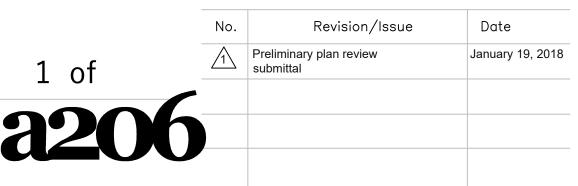
ROOFING TO BE 50 YEAR ASPHALT OVER 30# FELT, 5/8 CDX PLYWOOD/OSB.

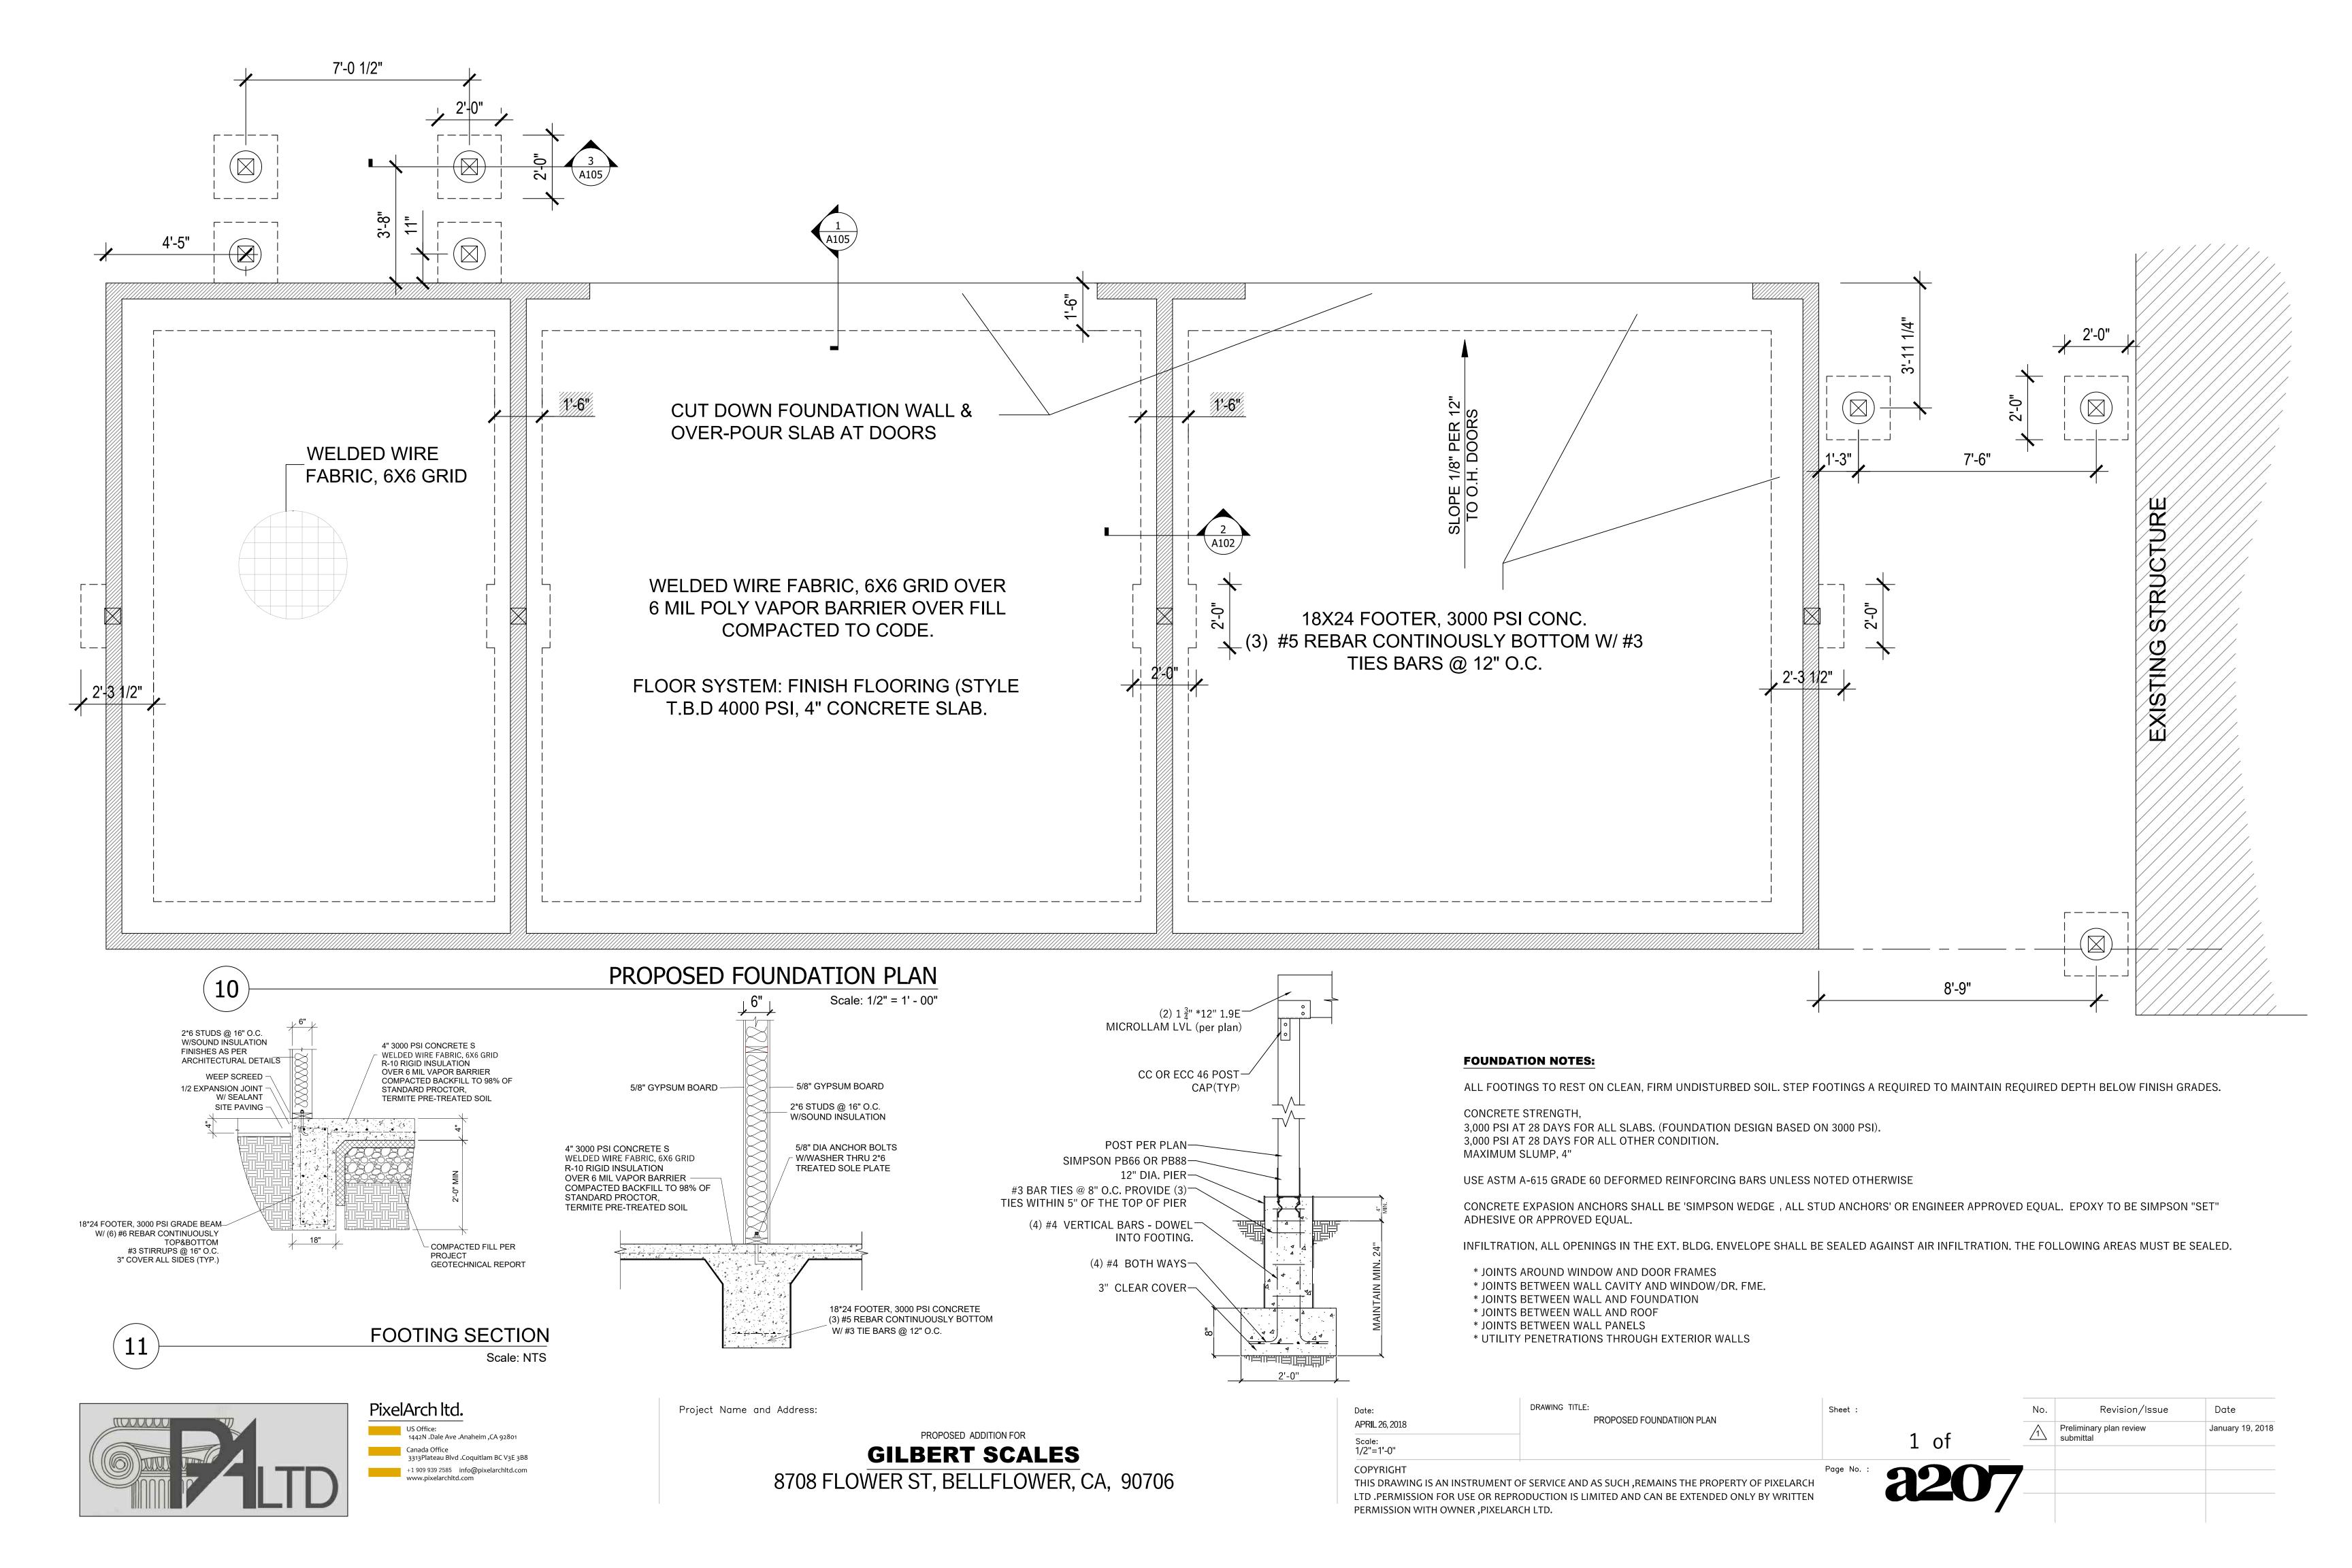
DECKING TO BE TREX OR WOOD. FINAL MATERIAL AND COLOR BY OWNER.

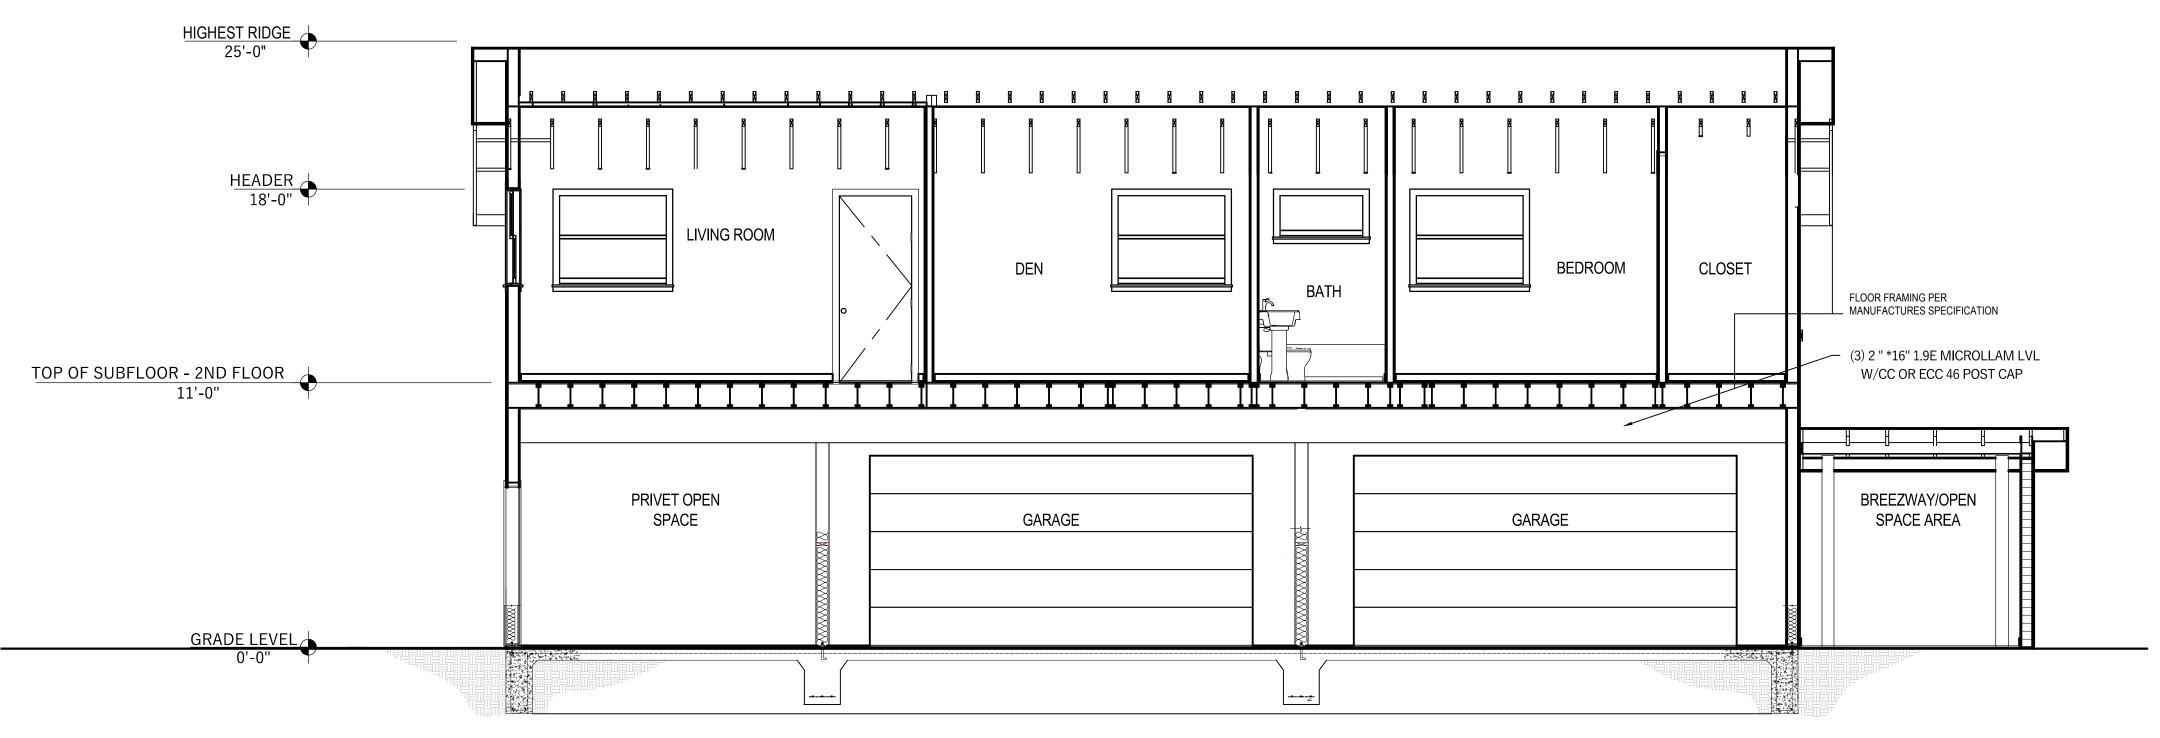
BASALT RETAINING WALLS TO MATCH EXISTING RETAINING WALL.

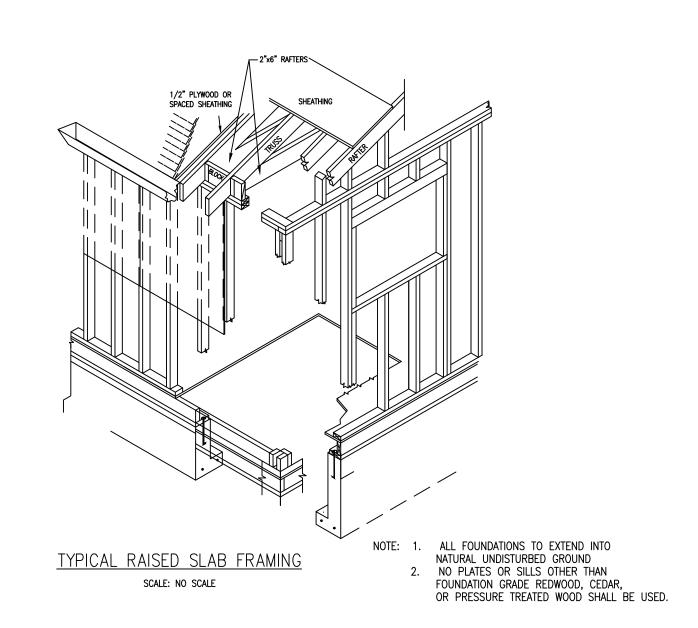
CHIMNEYS ARE DECORATIVE AND PROVIDE FOR VENTING OF GAS FIREPLACES ONLY.

FINISH GRADE SHALL SLOPE AWAY FROM STRUCTURE MIN. 1/2" PER FOOT OF RUN FOR 4' MIN.









PROPOSED CROSS SECTION Scale: 1/4" = 1' - 00"

2" PLANKS

TIMBER ROOF TRUSSES PER HIGHEST RIDGE 25'-0" MANUFACTURES SPECIFICATION KITCHEN LIVING ROOM TOP OF SUBFLOOR - 2ND FLOOR HEADER 8'-0" ─ (3) 2 " *16" 1.9E MICROLLAM LVL W/CC OR ECC 46 POST CAP STRUCTURAL TIMBER — POST 6"*6" DOUGLAS FIR, LARCH STRUCTURAL GRADE GRADE LEVEL

PROPOSED CROSS SECTION

NAILING NOTES: (PER IRC TABLE R602.3(1))

JOIST TO SILL OR GIRDER BRIDGING TO JOIST SOLE PLATE TO JOIST OR BLK'G STUD TO SOLE PLATE TOP PLATE TO STUD

DOUBLE STUDS DOUBLE TOP PLATES CONTINUOUS HEADER, TWO PIECES BUILT , UP HEADER, TWO PIECES W/ 1/2" SPACER TOP PLATES, LAPS AND INTERSECTIONS

CEILING JOISTS TO PLATE CONTINUOUS HEADER TO STUD CEILING JOISTS, LAPS OVER PARTITIONS CEILING JOISTS TO PARALLEL RAFTERS RAFTER TO PLATE 1" BRACE TO EACH STUD AND PLATE BUILT , UP CORNER STUDS

1/2" PLYWOOD ROOF AND WALL EDGES 8d @ 6" OC INTERMEDIATE 8d @ 12" OC SHEATHING 3/4" PLYWOOD SUBFLOOR EDGES 8d @ 6" OC

2x MULTIPLE JOISTS , STAGGER @ 15" OC W/(2) @ EA. END OR SPLICE

(3) OR FEWER 16d NAILS (4) OR MORE

1/2" DIA M.B. W/ STANDARD NUT AND WASHERS

FLOOR FRAMING &TRUSS NOTES:

FLOOR 40 :PSF LL. 10*PSF TOP CHORD DL. 5*PSF BOTTOM CHORD DL.

FLOORS 3AND 2SHALL HAVE "22FLOOR TRUSSES ;BOTTOM FLOOR IS CONCRETE SLAB.

SUB-FLOOR SHEATHING SHALL BE H ".1.125SHEATHING IS REQUIRED FOR ANY LONGITUDINAL(DRAG)FORCES .

TOE NAIL (3)-8d

END NAIL (2)-16d

FACE NAIL (2)-16d

TOE NAIL (3)-8d

TOE NAIL (4)-8d FACE NAIL (3)-10d

FACE NAIL (3)-10d

TOE NAIL (2)-16d

FACE NAIL (2)-8d

(2)-16d @ EA.BRG.

INTERMEDIATE 8d @ 12" OC

10d @ 24" OC

TOE NAIL EA. END (2)-8d

TOE NAIL (4)-8d, END NAIL (2) 16d

FACE NAIL 16d @ 16"OC

FACE NAIL 16d @ 24" OC

FACE NAIL 16d @ 16" OC

16d @ 16" OC ALONG EA. EDGE

16d @ 16" OC ALONG EA. EDGE

TRUSSES SPACED AT "24.00/C.

ALL PLATES ARE 1.5X 4UNO

TRUSS DRAWING IS FOR ILLUSTRATION ONLY .ALL TRUSSES SHALL BE INSTALLED &BRACED TO MANUFACTURERS DRAWINGS & SPECIFICATIONS.

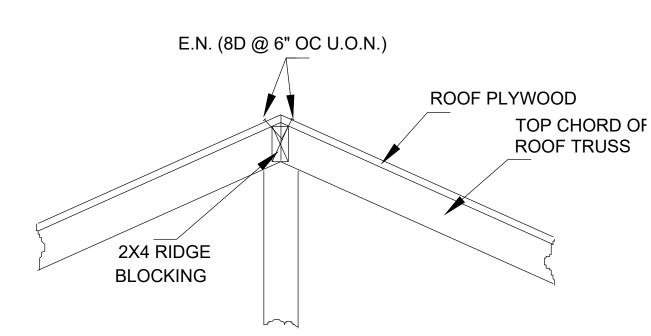
DEFLECTION MEETS L 480/LIVE AND L 360/TOTAL LOAD.

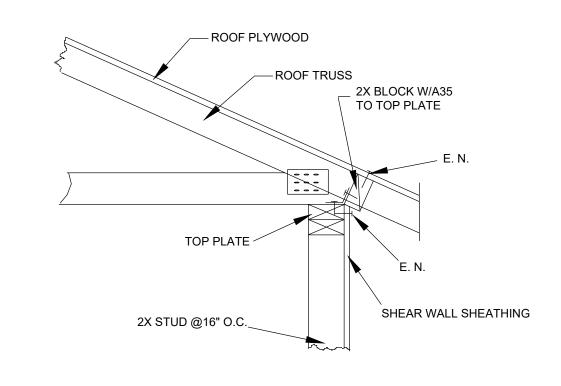
FASTEN RATED SHEATHING TO ONE FACE OF THIS FRAME.

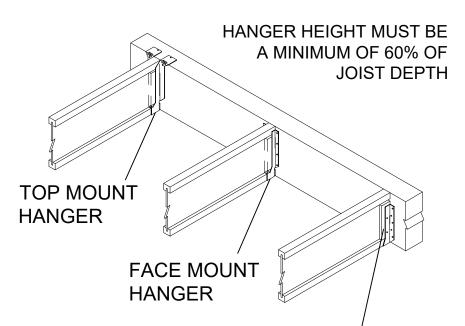
ALL TRUSSES WILL NOT BE FIELD ALTERED WITHOUT PRIOR BUILDING DEPT .APPROVAL OF ENGINEERING CALCULATIONS.

ALL TRUSSES SHALL HAVE DESIGN DETAILS &DRAWINGS ON SITE FOR FRAMING INSPECTION.


ALL FLOOR TRUSSES SHALL CARRY MANUFACTURERS STAMP.







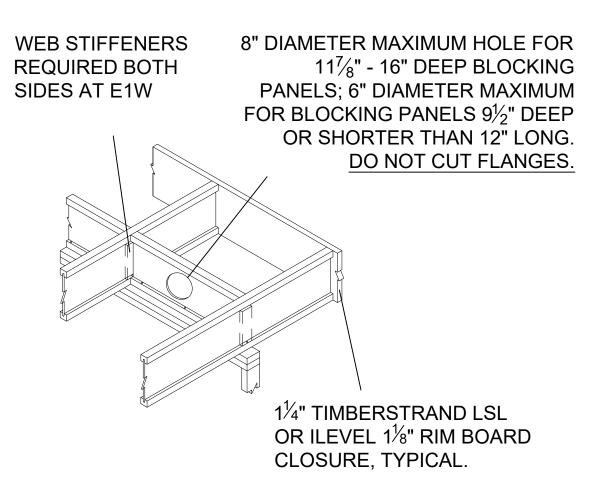WEB STIFFENERS REQUIRED IF SIDES OF HANGER DO NOT LATERALLY SUPPORT AT LEAST 3/8" OF TJI JOIST **TOP FLANGE**



Date

January 19, 2018

Revision/Issue

FLOORS AND ROOFS

ALL EXPOSED INSULATION IS TO HAVE A FLAME SPREAD RATING OF LESS THEN 25 AND A SMOKE DENSITY RATING OF LESS THAN 450.

PROVIDE INSULATION BAFFLES AT EAVE VENTS BETWEEN RAFTERS.

SPECIFIC MANUFACTURES AND MODEL NUMBERS SHOWN ON THE PLANS ARE INDICATIONS OF QUALITY ONLY. THE OWNER/BUILDER SHALL NOT BE PROHIBITED FROM SUBSTITUTING MATERIALS AND/OR APPLIANCES OF EQUAL QUALITY/STRENGTHS FROM NON, SPECIFIED MANUFACTURERS.

THE OWNER/BUILDER SHALL NOT BE SUBSTITUTING MATERIALS PROVIDED THEY MEET CURRENT BLDG. CODE, AND ARE APPROVED FOR THAT SPECIFIC USE BY THE BUILDING OFFICIAL

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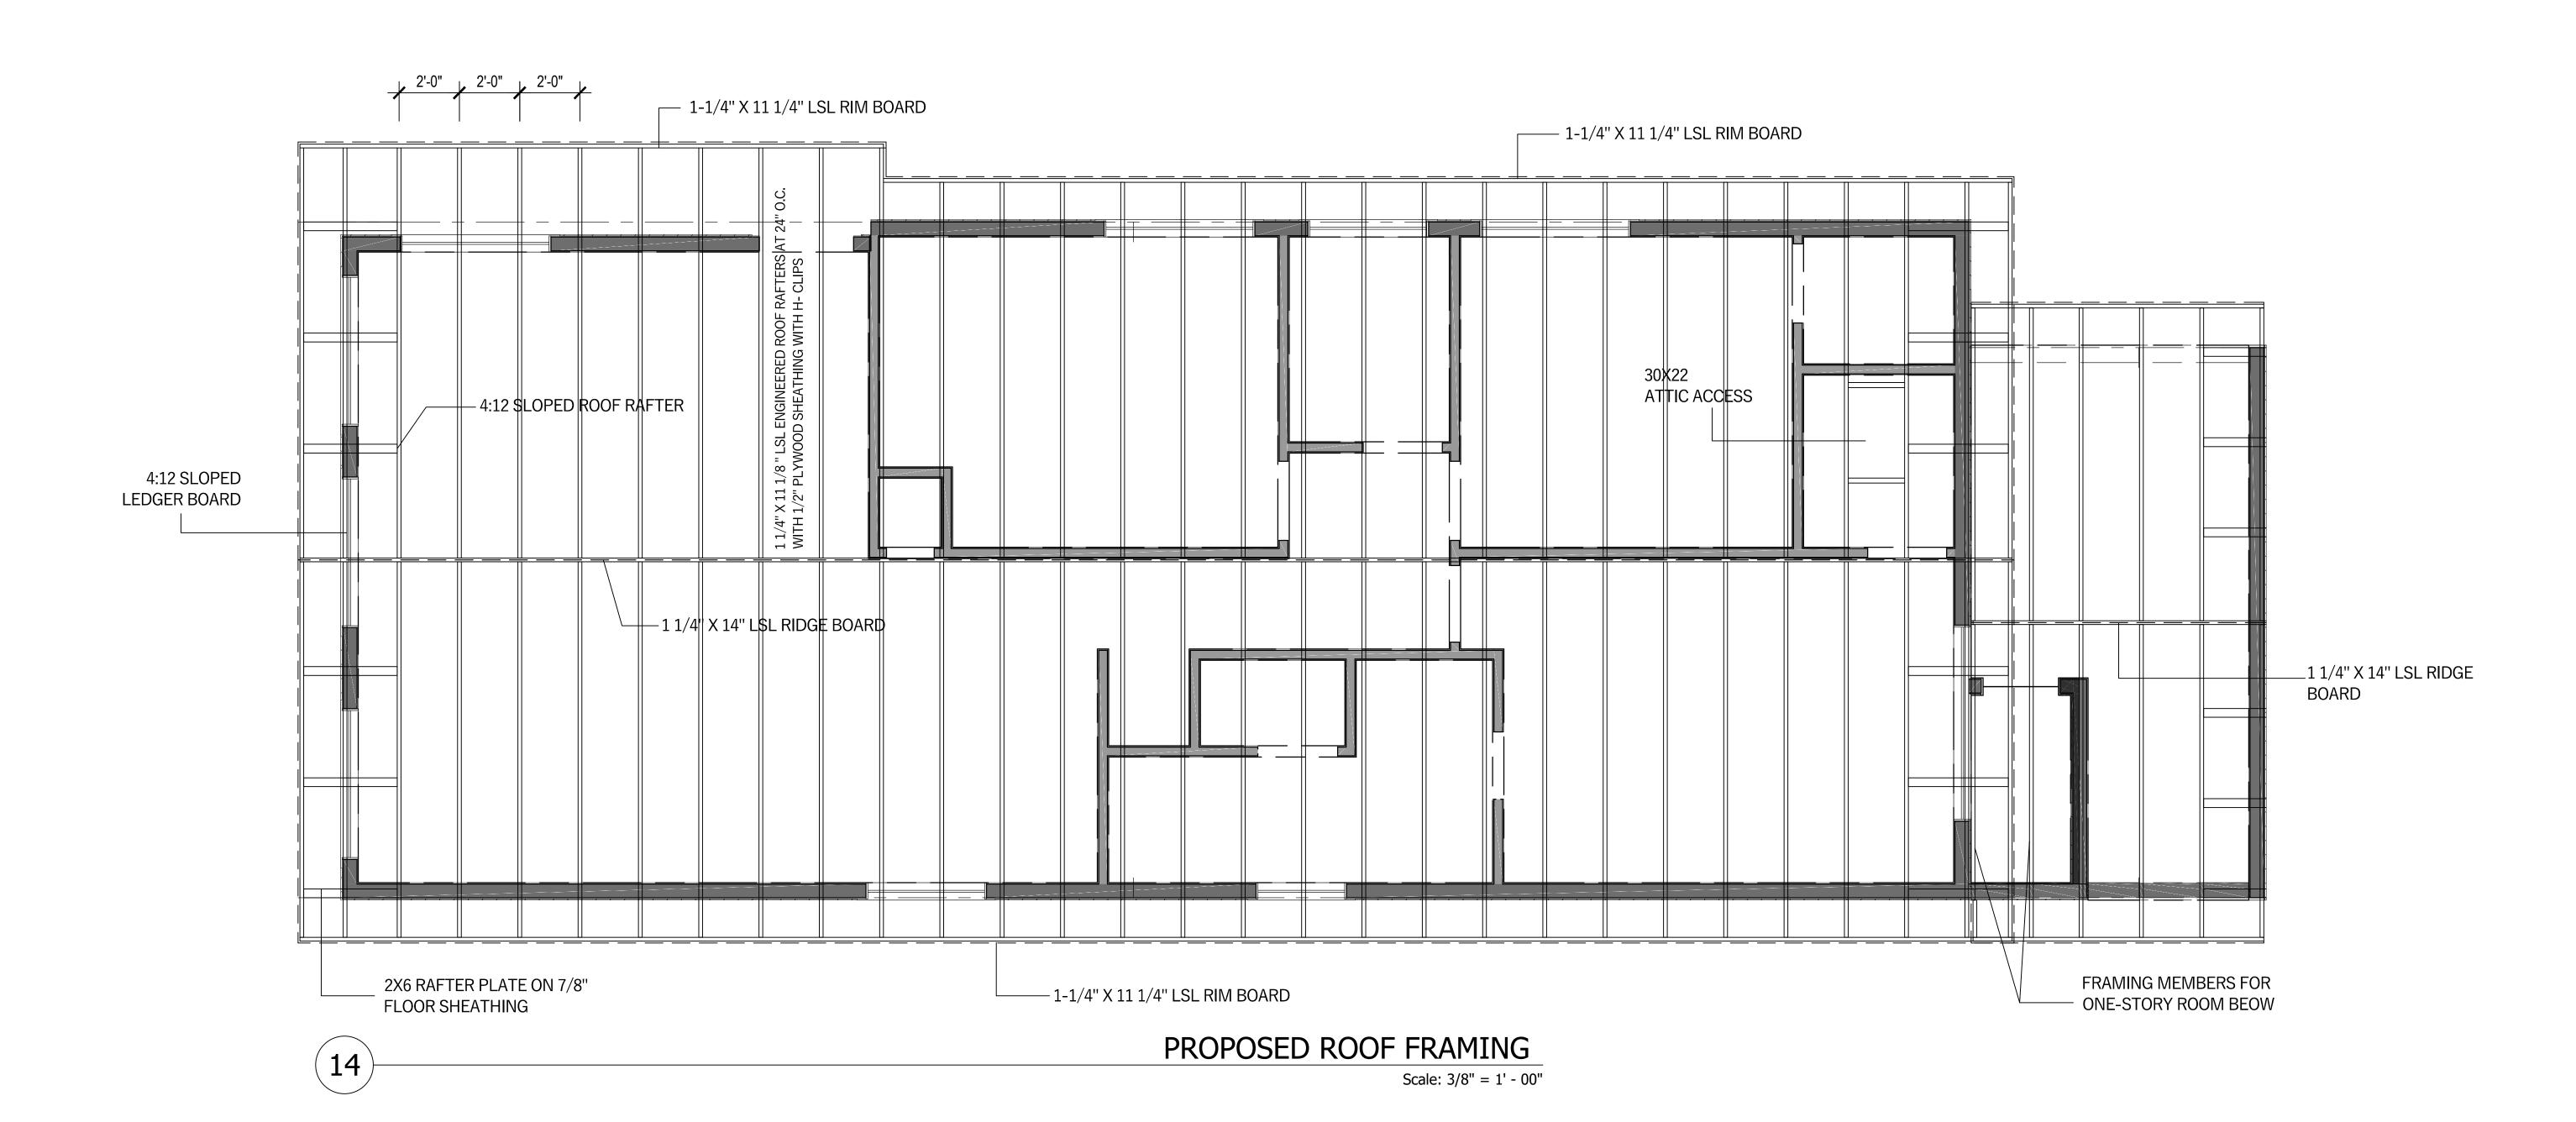
PROPOSED ADDITION FOR

GILBERT SCALES

8708 FLOWER ST, BELLFLOWER, CA, 90706

DRAWING TITLE: Date: PROPOSED CROSS SECTIONS APRIL 26, 2018 Preliminary submittal Preliminary plan review Scale: 1/4"=1'-0"

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TRUSS NOTES:

ATTIC VENTILATION: AREA / 300

PROVIDE 1" MIN. AIR GAP AT EAVES WITH INSULATION BAFFLES TYP. AT ALL TRUSS BAYS.

PROVIDE GABLE VENTS ALL GABLE ENDS.

PROVIDE GALV. ROOF VENTS ON BACKSIDE OF ROOFLINE ABOVE CONDITIONED AREA. 11.000110120.

1. ALL TRUSSES SHALL CARRY MANUFACTURERS STAMP.

2. ALL TRUSSES SHALL BE INSTALLED & BRACED TO MANUFACTURERS SPECIFICATIONS.

3. ALL TRUSSES WILL NOT BE FIELD ALTERED WITHOUT PRIOR BUILDING DEPT. APPROVAL OF ENGINEERING CALCULATIONS.

4. ALL TRUSSES SHALL HAVE DESIGN DETAILS & DRAWINGS ON SITE FOR FRAMING INSPECTION.

5. NON BEARING WALLS SHOULD BE HELD DOWN FROM THE TRUSS BOTTOM CHORD W/ SIMPSON STC TO INSURE THAT THE TRUSS BOTTOM CHORD WILL NOT BEAR ON THE WALL.

6. ALL CONNECTIONS OF RAFTERS, JACK OR HIP TRUSSES TO MAIN GIRDER TO BE PROVIDED BY TRUSS MANUFACTURE.

7. ALL ROOF FRAMING 24" O.C.

8. ALL ROOF PITCH 4:12

9. SCISSORS TRUSS CEILING PITCH 2:12.

10. TRUSSES MANUFACTURED BY

11. ALL OVERHANGS 16".

WALL PANEL NOTES:

B.P. BRACED WALL PANEL

3'-4" MIN. LENGTH w/ 7/16" OSB OR 1/2" PLYWOOD AND 8d COMMONS 6" o/c AT ALL PANEL EDGES, 12" o/c FIELD.

I.B.P. INTERIOR BRACED WALL PANEL

1/2" GYP. BD PER R 602.10.3(5); 1/2 GWB EACH SIDE w/ #6 X 1 1/4 TYPE S OR W SCREWS PERS ASTM C1002 @ 7" o/c @ ALL SUPPORTS

A.B.P. ALTERNATE BRACED WALL PANEL

2'-8" MIN. WIDTH w/ 7/16" OSB OR 1/2" PLYWOOD AND 8d COMMONS 6" o/c AT ALL PANEL EDGES, 12" o/c FIELD & (2) A.B. PER PANEL LOCATED AT 1/4 POINTS & 1800# MIN. HOLDDOWN EACH END *HPAHD22 OR STD10)

FRAMING NOTES:

PROVIDE DOUBLE JSTS .UNDER ALL WALLS RUNNING PARALLEL TO JOISTS.

PROVIDE POSITIVE VENTILATION AT EA .END OF EA .RAFTER SPACE AT VAULTED CEILING AREAS.

PROVIDE FIRE BLOCKING ,DRAFT STOPS AND FIRE STOPS AS PER I.B.C .SEC .R.502.12

PROVIDE POSITIVE CONNECTIONS AT EACH END OF ALL POSTS AND COLUMNS TO RESIST LATERAL DISPLACEMENT.



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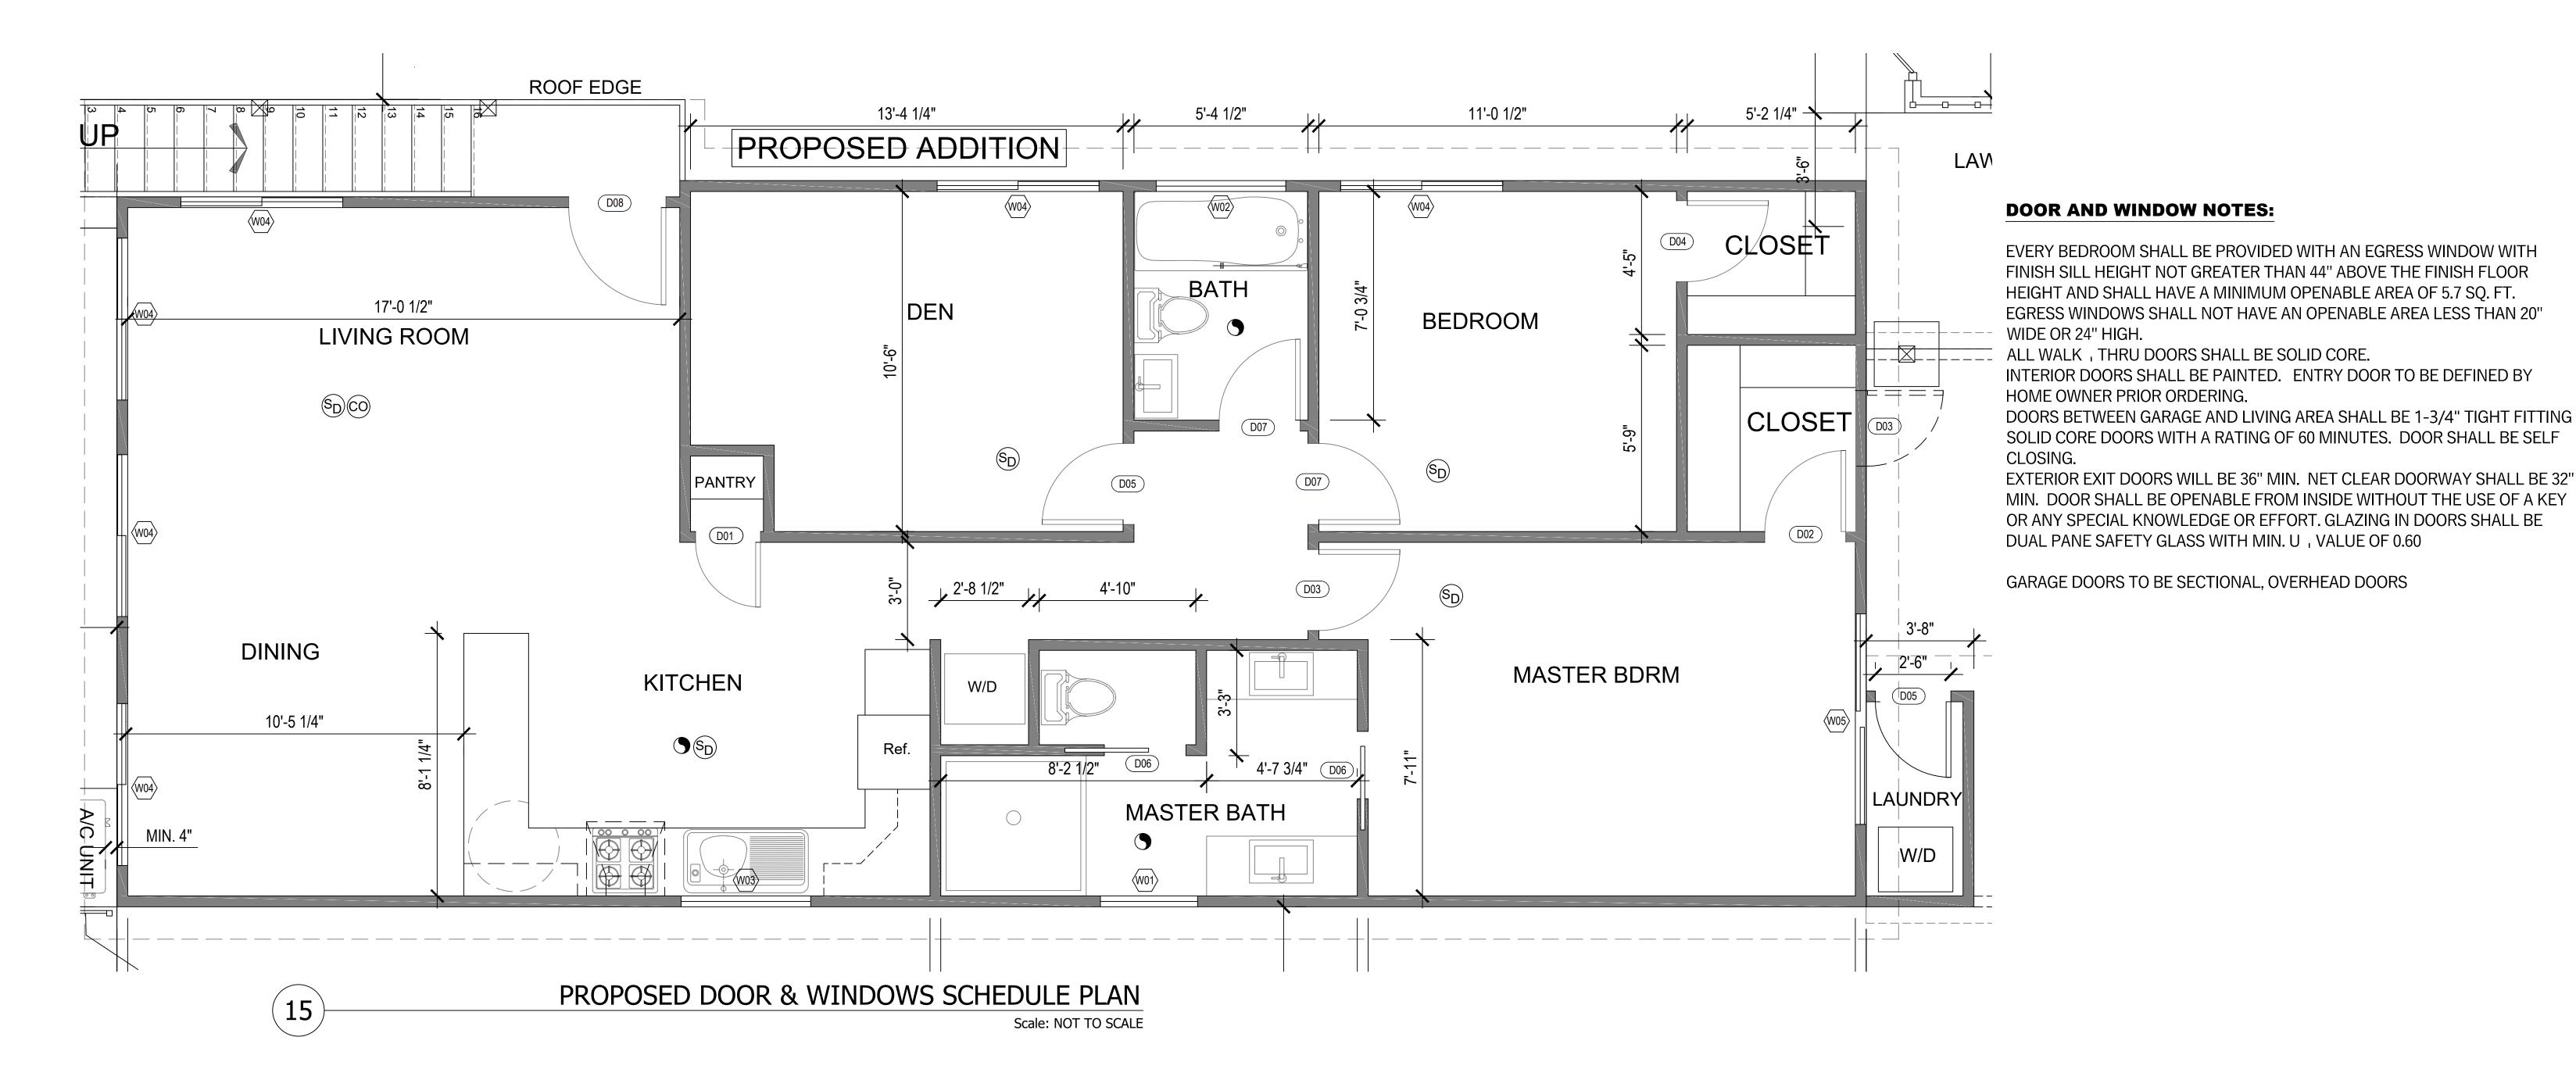
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PROPOSED ADDITION FOR

GILBERT SCALES8708 FLOWER ST, BELLFLOWER, CA, 90706

Date: APRIL 26, 2018 Scale: 1/4"=1'-0"	DRAWING TITLE: PROPOSED ROOF FRAMING PLAN	Sheet :	1 of	No.	Revision/Issue Preliminary plan review submittal	Date January 19, 2018
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								DOOR SCHEDULE				
Number	Label	Qty	Floor	Size	Width	Height	R/O	Description	Header	Thickness	Code	Comments
D01	2080	1	2	2080 L IN	24 "	96 "	26"x98 1/2"	Hinged-Slab	2x6x29" (2)	1 3/8"		SLAB DOOR PAINT GRADE
D02	2480	1	2	2480 R IN	28 "	96 "	30"x98 1/2"	Hinged-Slab	2x6x33" (2)	1 3/8"		SLAB DOOR PAINT GRADE
D03	2480	2	2	2480 L IN	27 1/2 "	96 "	29 1/2"x98 1/2"	Hinged-Slab	2x6x32 1/2" (2)	1 3/8"		SLAB DOOR PAINT GRADE
D04	2480	1	2	2480 L IN	28 "	96 "	30"x98 1/2"	Hinged-Slab	2x6x33" (2)	1 3/8"		SLAB DOOR PAINT GRADE
D05	2680	2	2 & 1	2680 L IN	30 "	96 "	32"x98 1/2"	Hinged-Slab	2x6x35" (2)	1 3/8"		SLAB DOOR PAINT GRADE
D06	2680	2	2	2680 R	30 "	96 "	62"x98 1/2"	Pocket-Slab	2x6x65" (2)	1 3/8"		SLAB DOOR PAINT GRADE
D07	2680	2	2	2680 R IN	30 "	96 "	32"x98 1/2"	Hinged-Slab	2x6x35" (2)	1 3/8"		SLAB DOOR PAINT GRADE
D08	3080	1	2	3080 L EX	36 "	96 "	38"x99"	ext. Hinged-Slab	2x6x41" (2)	1 3/4"		STEEL OR FIBERGLASS SKIN W/POLYURETHANE CORE MIN. R-6

	WINDOW SCHEDULE											
Number	Label	Qty	Floor	Size	Width	Height	R/O	Egress	Description	Header	Code	Comments
W01	3040DH	1	1	3040DH	36 "	48 "	38 3/8"x50 3/8"		Double Hung	2x6x41 3/8" (2)		PLAIN WHITE VINYL DUAL GLAZE ,NO GRIDS
W02	4020DH		1	4020DH	48 "	24 "	50 3/8"x26 3/8"		Double Hung	2x8x53 3/8" (2)		PLAIN WHITE VINYL DUAL GLAZE ,NO GRIDS
W03	4040DH		1	4040DH	48 "	48 "	50 3/8"x50 3/8"		Double Hung	2x8x53 3/8" (2)		PLAIN WHITE VINYL DUAL GLAZE ,NO GRIDS
W04	5040DH		1	5040DH		48 "	62 3/8"x50 3/8"		Double Hung	2x8x65 3/8" (2)		PLAIN WHITE VINYL DUAL GLAZE ,NO GRIDS
W05	6640DH		1	6640DH		48 "	80 3/8"x50 3/8"		Double Hung	2x10x83 3/8" (2)		PLAIN WHITE VINYL DUAL GLAZE ,NO GRIDS

THE SCHEDULE SHEET PROVIDES DETAILS ON SPECIFIC COMPONENTS TO ASSURE COMPLIANCE WITH CERTIFICATION PROGRAMS LIKE THE ICC 700 NATIONAL GREEN BUILDING STANDARD, ENERGY STAR, OR LEED FOR HOMES.



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PROPOSED ADDITION FOR GILBERT SCALES

8708 FLOWER ST, BELLFLOWER, CA, 90706

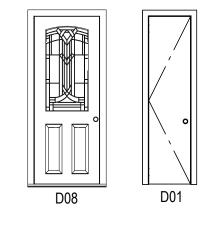
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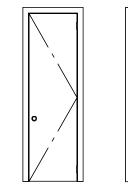
DESIGN SHGC = 0.40


U-VALUE AND SOLAR HEAT GAIN COEFFICIENT (SHGC) MINIMUMS PER CLIMATE ZONE 3A




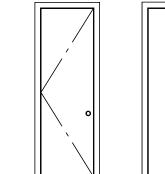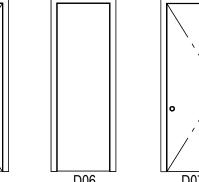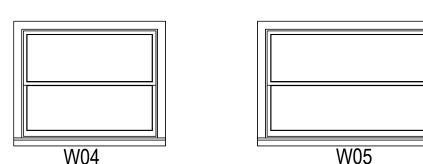
EXTERIOR) W/ INSULATED CORE, FACTORY FINISH

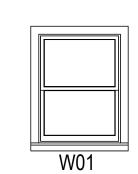


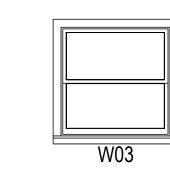


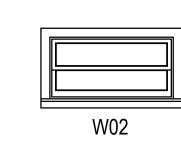


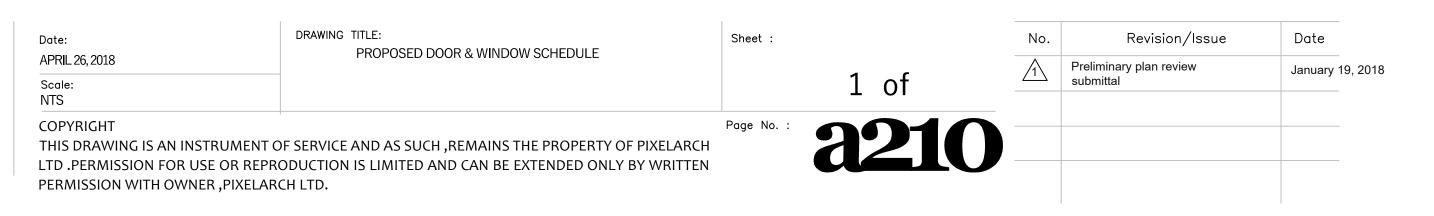


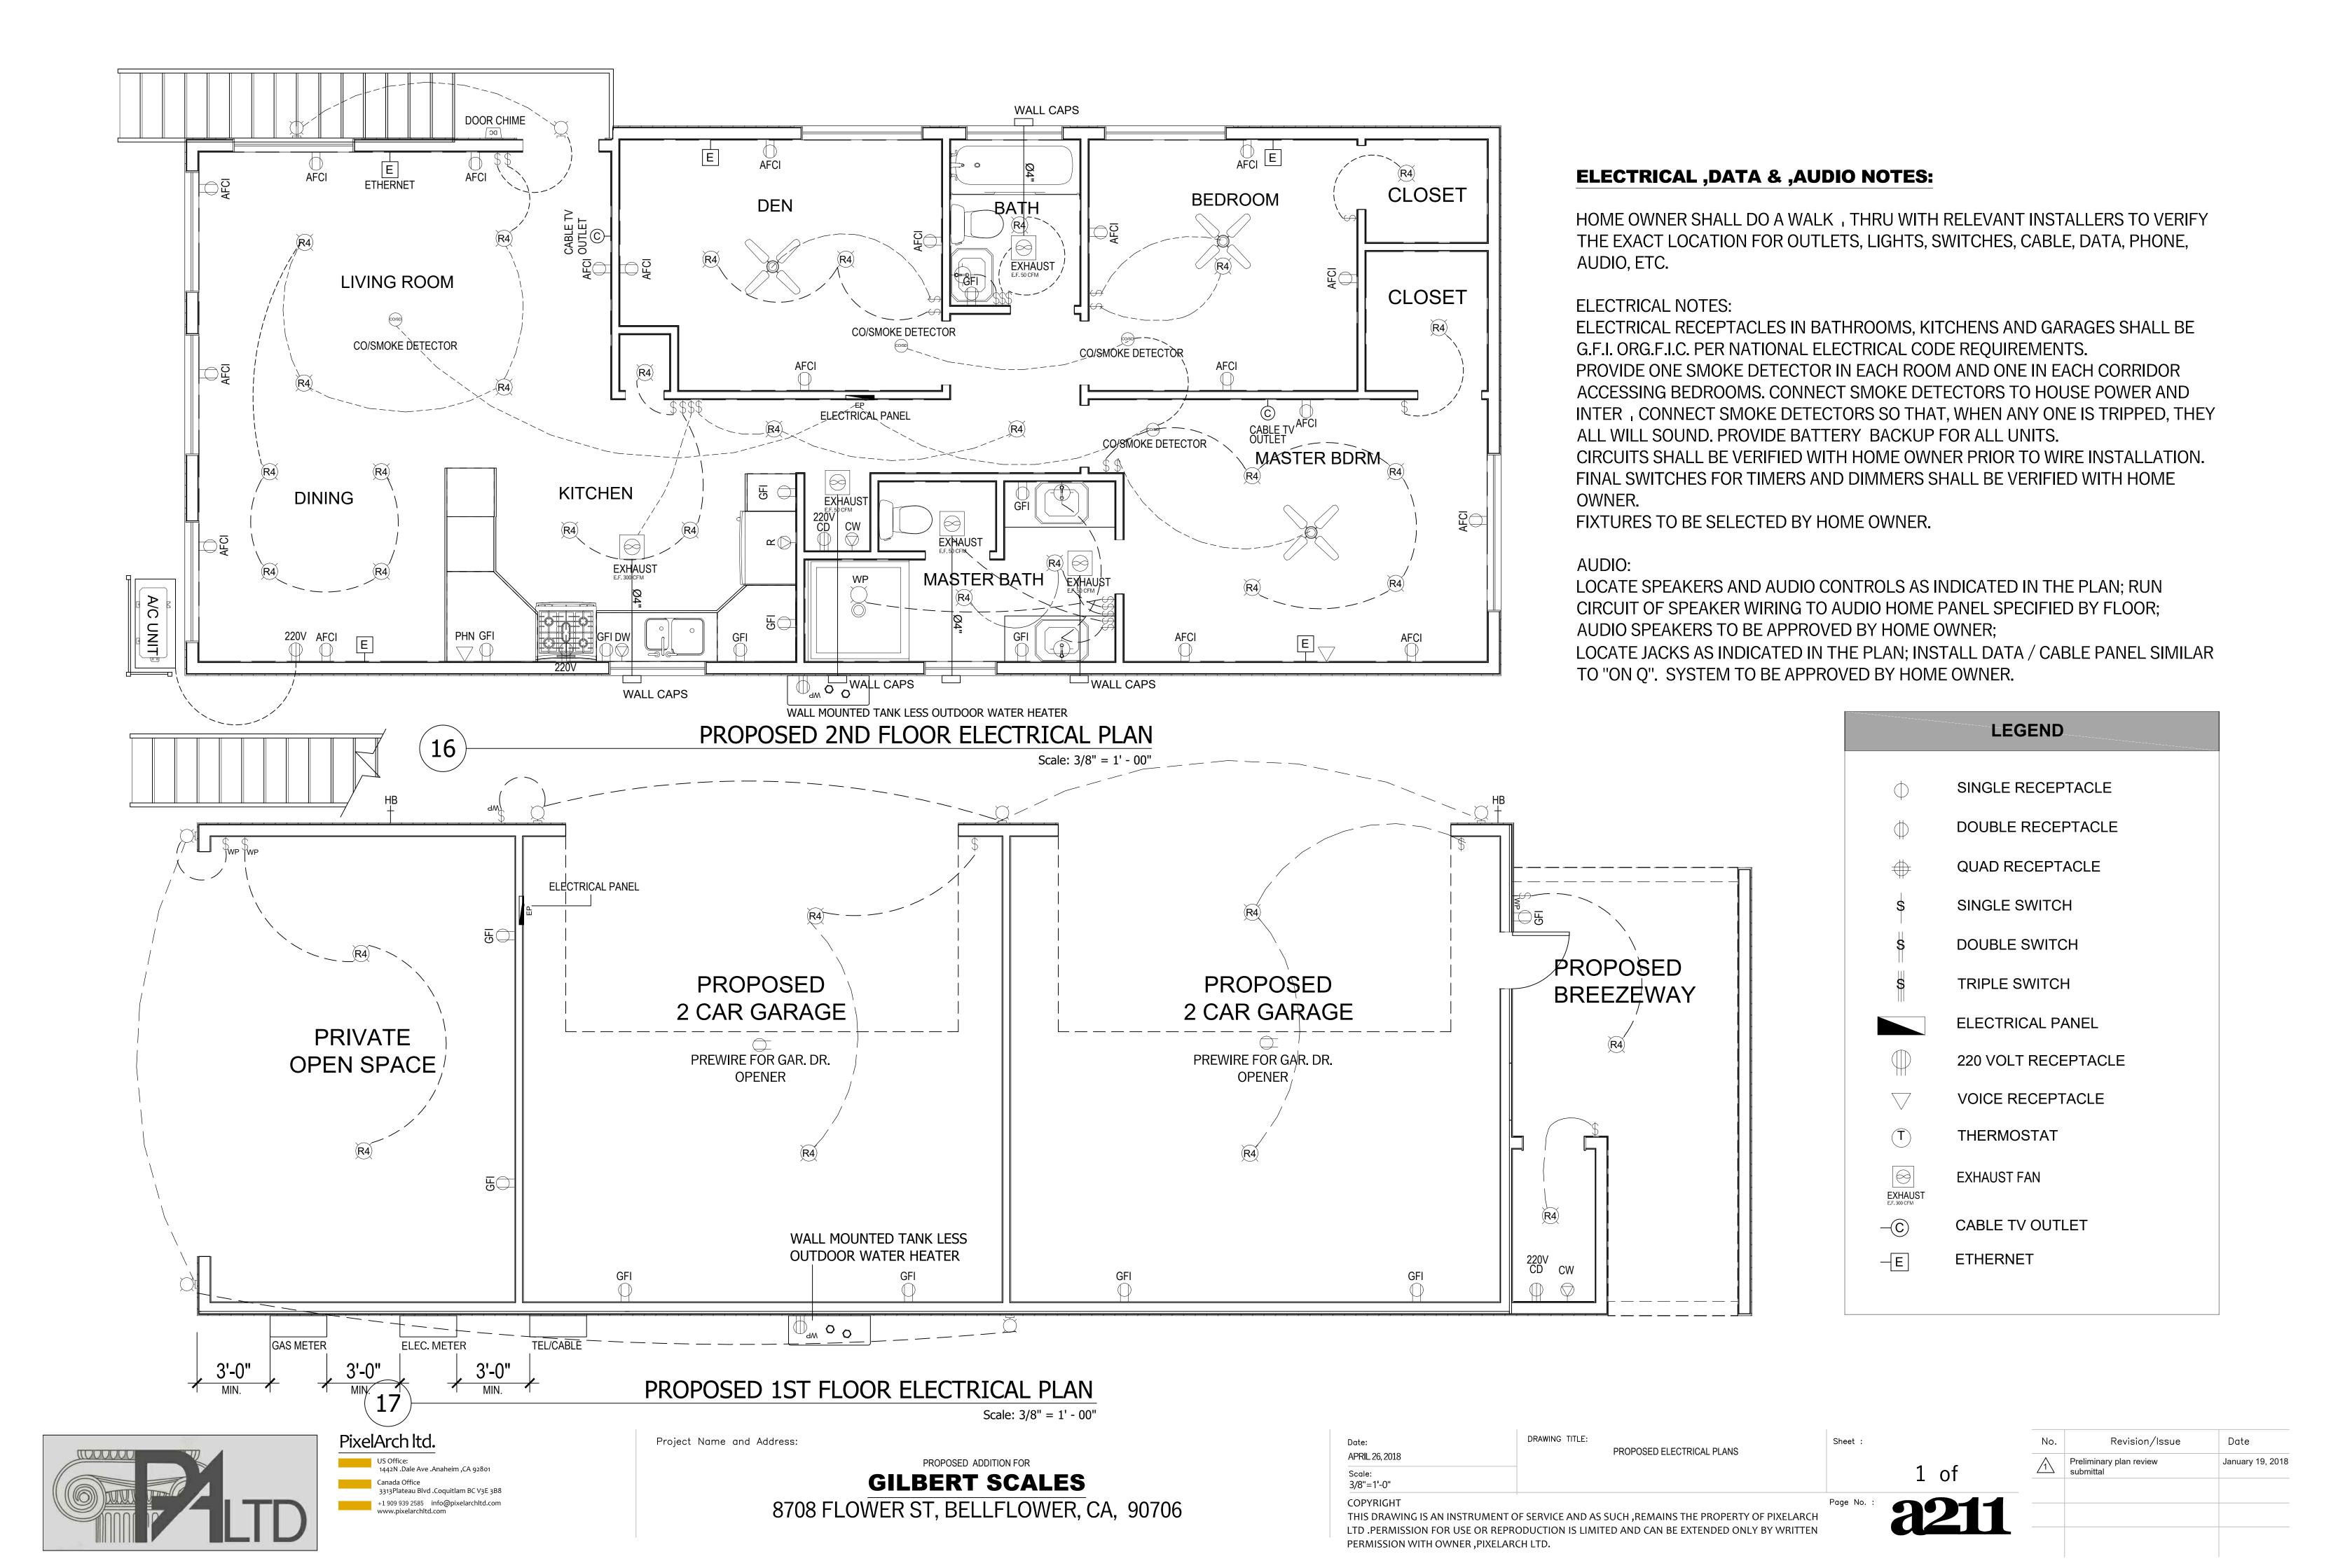












PANEL TAG	P2
PANEL LOCATION	2ND FLOOR
RATED SWITCH AMPER	100A 2POLES
PHASE	2
VOLTAGE	120-240
WIRES	3
LINES	24


				2ND FLOC	OR ELECTRIC	CAL BOX (24 LINES)								
CIRCUIT	DESCRIPTION	LOAD TYPE	BREAKER SIZE	POLES	WIRE SIZE	Α	В	Α	В	WIRE SIZE	POLES	BREAKER SIZE	LOAD TYPE	DESCRIPTION	CIRCUIT
1	WATER HEATER	D	30A	2	3 - #10	2		0/24		3 - #12	1	15A	L	DEN LIGHTS & FAN	13
2	VVATENTILATEN	I N	30A		3-#10		2		0/3	3 - #12	1	20A	R	DEN RECEPTACLE	14
3	CD	D	30A	2	3 - #10	1/5		0/24		3 - #12	1	15A	L	BEDROOM &CLOSET LIGHTS	15
4		IN	30A		3-#10		1/5		0/2	3 - #12	1	20A	R	BEDROOM RECEPTACLE	16
5	AC UNIT	D	20A	2	3 - #12	1		0/24		3 - #12	1	15A	L	MASTER BEDROOM &CLOSET LIGHTS	17
6	AC ONT		20A		3-#12		1		0/2	3 - #12	1	20A	R	MASTER BEDROOM RECEPTACLE	18
7	OVEN		30A	2	3 - #10	2		0/12		3 - #12	1	15A	L & EXHAUST	MASTER BATH LIGHTS & EXAUST	19
8	OVEN	R	JUA		3-#10		2		0/5	3 - #12	1	20A	R	MASTER BATH RECEPTACLE	20
9	LIVING ROOM & DINING ROOM LIGHTS	L	15A	1	3 - #12	0/42		0/18		3 - #12	1	15A	L & EXHAUST	BATH LIGHTS & EXAUST	21
10	LIVING ROOM & DINING ROOM RECEPTACLES	R	20A	1	3 - #12		0/2		0/1	3 - #12	1	20A	R	BATH RECEPTACLE	22
11	KITCHEN RECEPTACLES	R	20A	1	3 - #12	0/3		1/5		3 - #10	1	30A	R	DW	23
12	KITCHEN & HALLWAY LIGHTS & EXHAUST	L & EXHAUST	15A	1	3 - #12		0/24		2	3 - #10	1	30A	R	CW	24

CONNECTED LOAD A	9/74
CONNECTED LOAD B	10/24
TOTAL LOAD	19/98
TOTAL AMPER	77 A

				1ST FLOOR	R ELECTRIC	AL BOX (12	LINES)								
CIRCUIT	DESCRIPTION	LOAD TYPE	BREAKER SIZE	POLES	WIRE SIZE	А	В	Α	В	WIRE SIZE	POLES	BREAKER SIZE	LOAD TYPE	DESCRIPTION	CIRCUIT
1	CD	D	30A	2	3 - #10	1/5		0/5		3 - #12	1	20A	R	GARAGE RECEPTACLES	7
2	CD	IN I	30A		3-#10		1/5		0/12	3 - #12	1	15A	L	BREEZEWAY LIGHTS	8
3	WATER HEATER	D	30A	2	3 - #10	2		0/42		3 - #12	1	15A	L	GARAGE & EXTERIOR LIGHTS	9
4	VVATEITTILATEIT	IX	30A		3-#10		2		0/35	3 - #12	1	15A	L	PRIVATE OPEN SPACE & EXTERIOR LIGHTS	10
5	CW	R	30A	1	3 - #10	2									11
6	CAR DOOR OPENER RECEPTACLE	R	20A	1	3 - #12		0/5								12

PANEL TAG	P1
PANEL LOCATION	1ST FLOOR
RATED SWITCH AMPER	60A 2POLES
PHASE	2
VOLTAGE	120-240
WIRES	3
LINES	12

DEMAND LOAD	30/87
DEMAND AMPER	121A

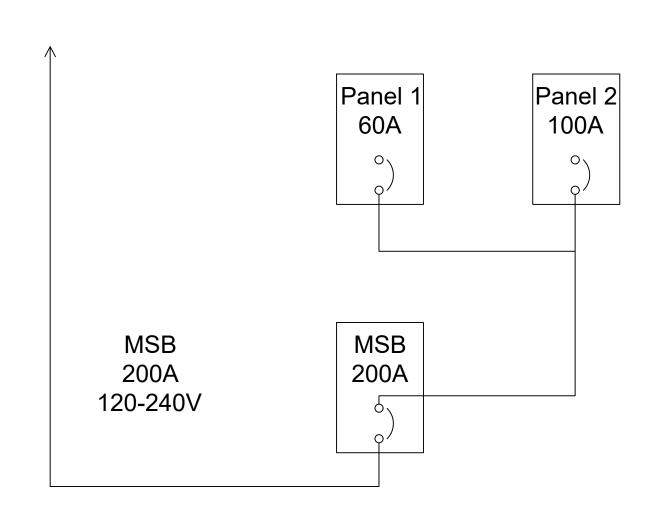

SINGLE LINE DIAGRAM



Project Name and Address:

PROPOSED ADDITION FOR

GILBERT SCALES

8708 FLOWER ST, BELLFLOWER, CA, 90706


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Annuary 19, 2018



PROPOSED 2ND FLOOR SANITARY PLAN

GENERAL PLUMBING NOTES:

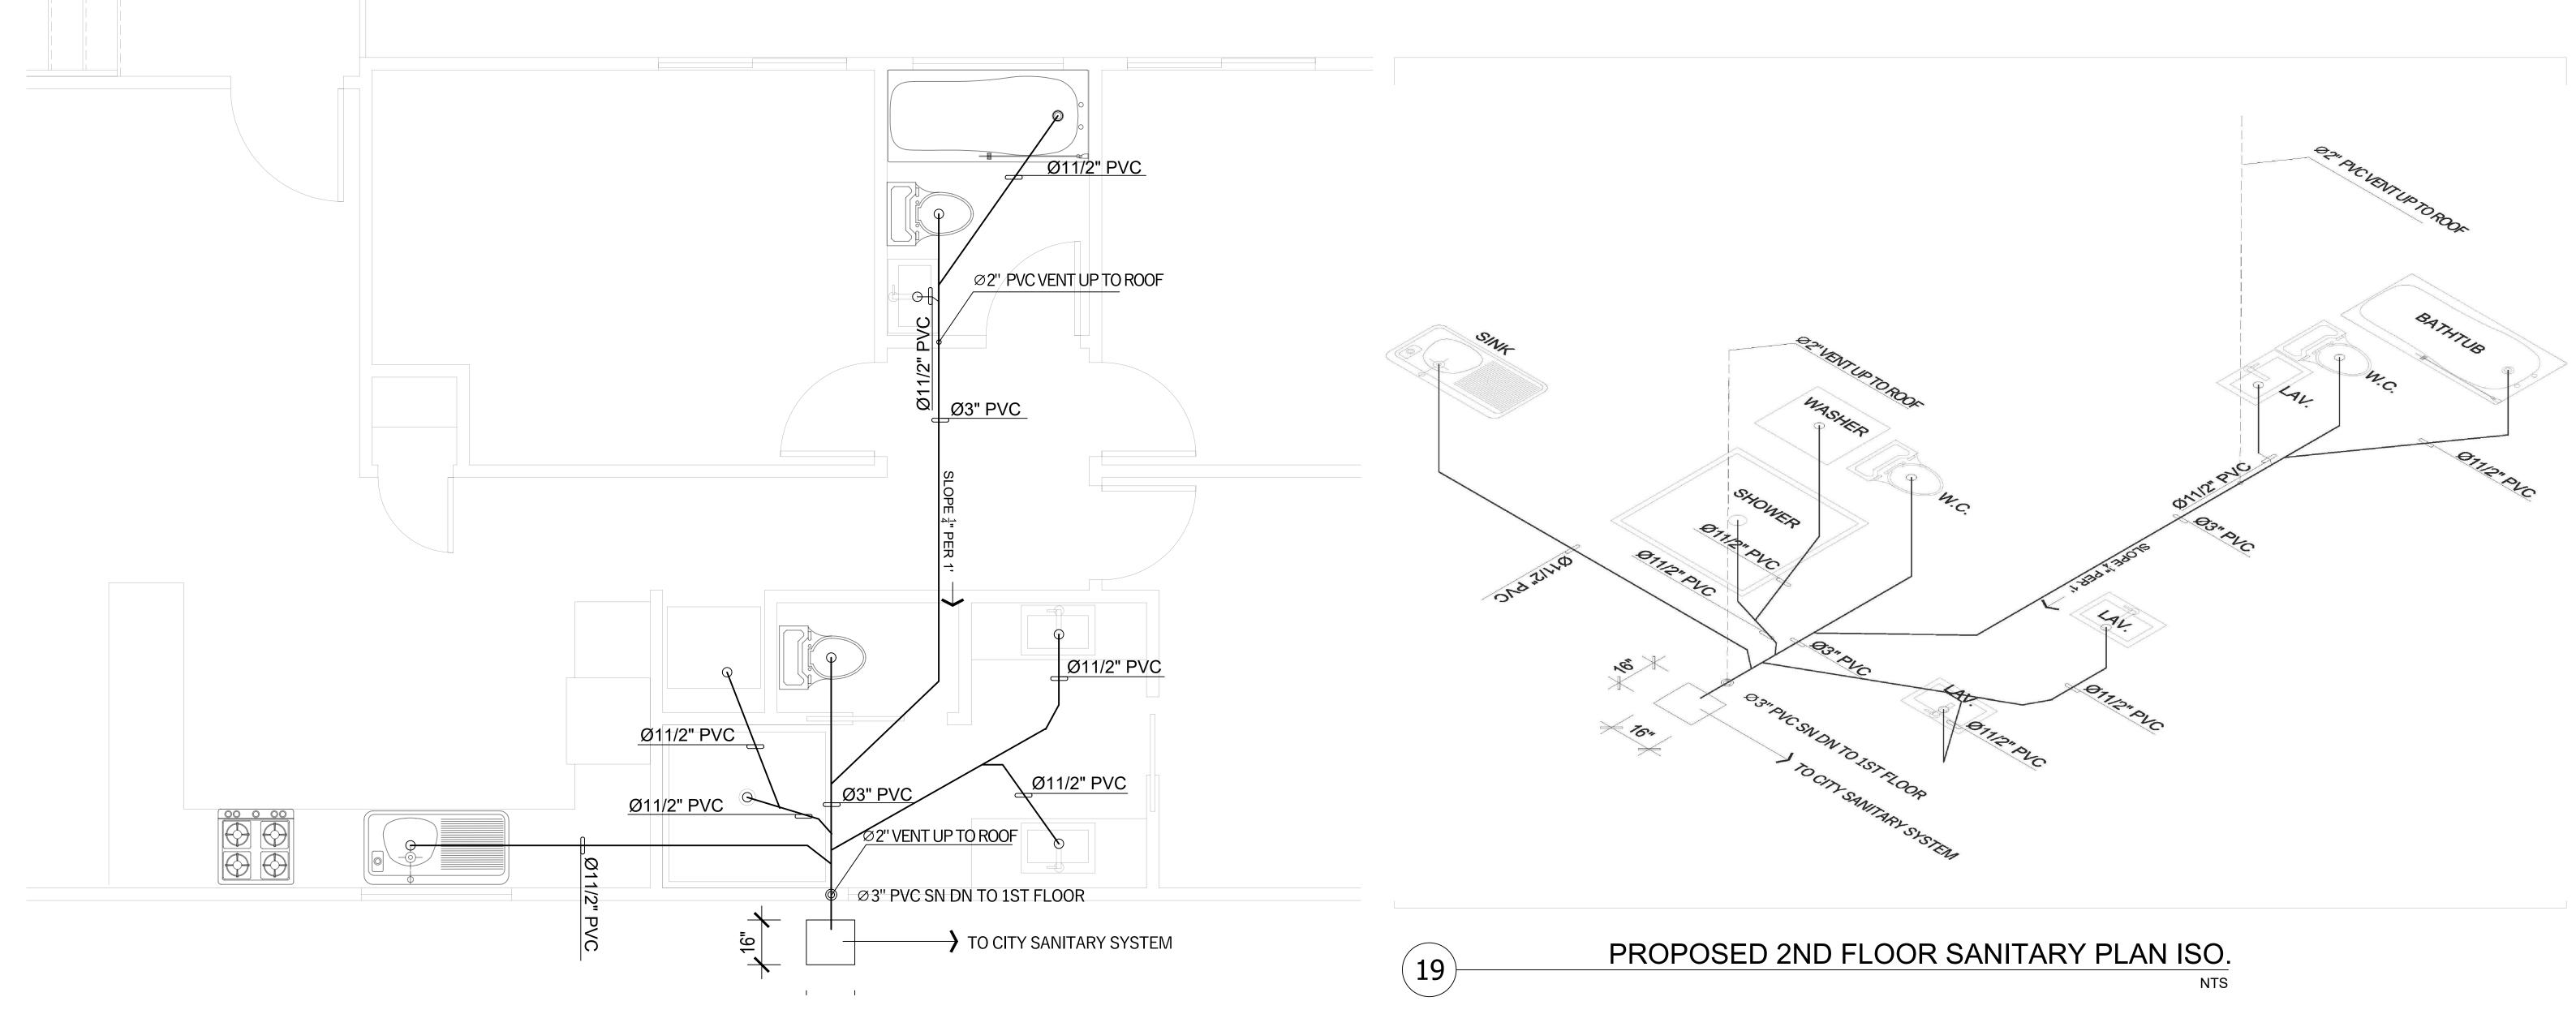THE FURNACE AND WATER HEATER ON FLOOR 1 SHALL SERVE FLOORS 1 & 2.

METALLIC GAS PIPE, WATER PIPE, AND FOUNDATION REINFORCING BARS SHALL BE BONDED TO THE ELECTRICAL SERVICE GROUND. DRYER, WATER HEATER, KITCHEN AND BATHROOM VENTING SHALL EXHAUST TO THE OUTSIDE OF THE BUILDING AND BE EQUIPPED WITH A BACK DRAFT DAMPER.

ALL GAS LINES SHALL BE SIZED FOR APPLIANCE LOAD. "BLACK" PIPE SHALL BE USED INSIDE THE BUILDING, "GREEN" PIPE WHERE UNDERGROUND OR EXPOSED TO WEATHER. ALL JOINTS SHALL BE TAPED WHERE BURIED OR EXPOSED TO WEATHER. TUBS/SHOWERS SHALL BE PROVIDED WITH INDIVIDUAL CONTROL VALVES OF THE PRESSURE BALANCE OR THE THERMOSTATIC

MIXING TYPE. THE WATER TEMPERATURE SHALL BE AT A MAXIMUM OF 120*F.
WATER SOFTENER UNIT SHALL CONDITION WATER BEFORE ENTERING THE WATER HEATERS AND THE COLD WATER SOURCE.

EACH HOSE BIBB SHALL BE EQUIPPED WITH A BACK FLOW PREVENTION DEVICE. HEAT DUCTING SHALL BE SECURED, SEALED AND INSULATED AS APPROPRIATE.

INSTALL WATERPROOF GYPSUM BOARD AT ALL WATER SPLASH AREAS TO MINIMUM 70" ABOVE SHOWER DRAINS.

INSULATE WASTE LINES FOR SOUND CONTROL.

INSTALL CENTRAL VACUUM SYSTEM & PIPING; CONFIRM BRAND WITH HOMEOWNER.

PLUMBING SYMBOL LEGEND					
SYMBOL	DESCRIPTION	SYMBOL	DESCRIPTION	SYMBOL	DESCRIPTION
	WASTE, SOIL AND STORM	•	BUTTERFLY VALVE	ıþı	UNION
	BURIED PIPE	† Z	CHECK VALVE	\bigcirc	CIRCULATING PUMP
	COLD	AA A	PRESSURE REDUCING VALVE		FLOOR DRAIN
	нот	† <u>†</u> Z	BACKFLOW PREVENTER	0	ROOF DRAIN
	RECIRCULATION	ıΦ	PLUG VALVE	—— <u> </u> ı	CLEAN OUT
	VENT	Ç.	CONTROL VALVE	<u> </u>	THERMOMETER
•	BALL VALVE	<u>_</u> 1	HOSE BIBB	<u> </u>	PIPE ELBOW UP
M	GATE VALVE	卜卜	PRESSURE RELIEF VALVE	—— <u>э</u>	PIPE ELBOW DN
<u></u>	OS&Y GATE VALVE	I	STRAINER		CAP

PLUMBING FIXTURE SCHEDULE								
ABBREV	TYPE	CONNECTION SIZES				DFU	CON	NOTES
7,881,127	IIFL	ט וט	CW	HW	SAN			
WC	WATER CLOSET	8	1/2"		3"			
LAV	LAVATORY	2	1/2"	1/2"	1 1/2"			
BATHTUB	BATHTUB	3	1/2"	1/2"	1 1/2"			
CLOTHES WASHING MACHINE	AUTOMATIC CLOTHES WASHING MACHINE	2	1/2"	1/2"	1 1/2"			
KITCHEN SINK	KITCHEN SINK	2	1/2"	1/2"	1 1/2"			

NOTE: ABOVE LEGEND IS GENERAL IN NATURE. NOT ALL SYMBOLS ARE ASSOCIATED WITH THIS PROJECT.



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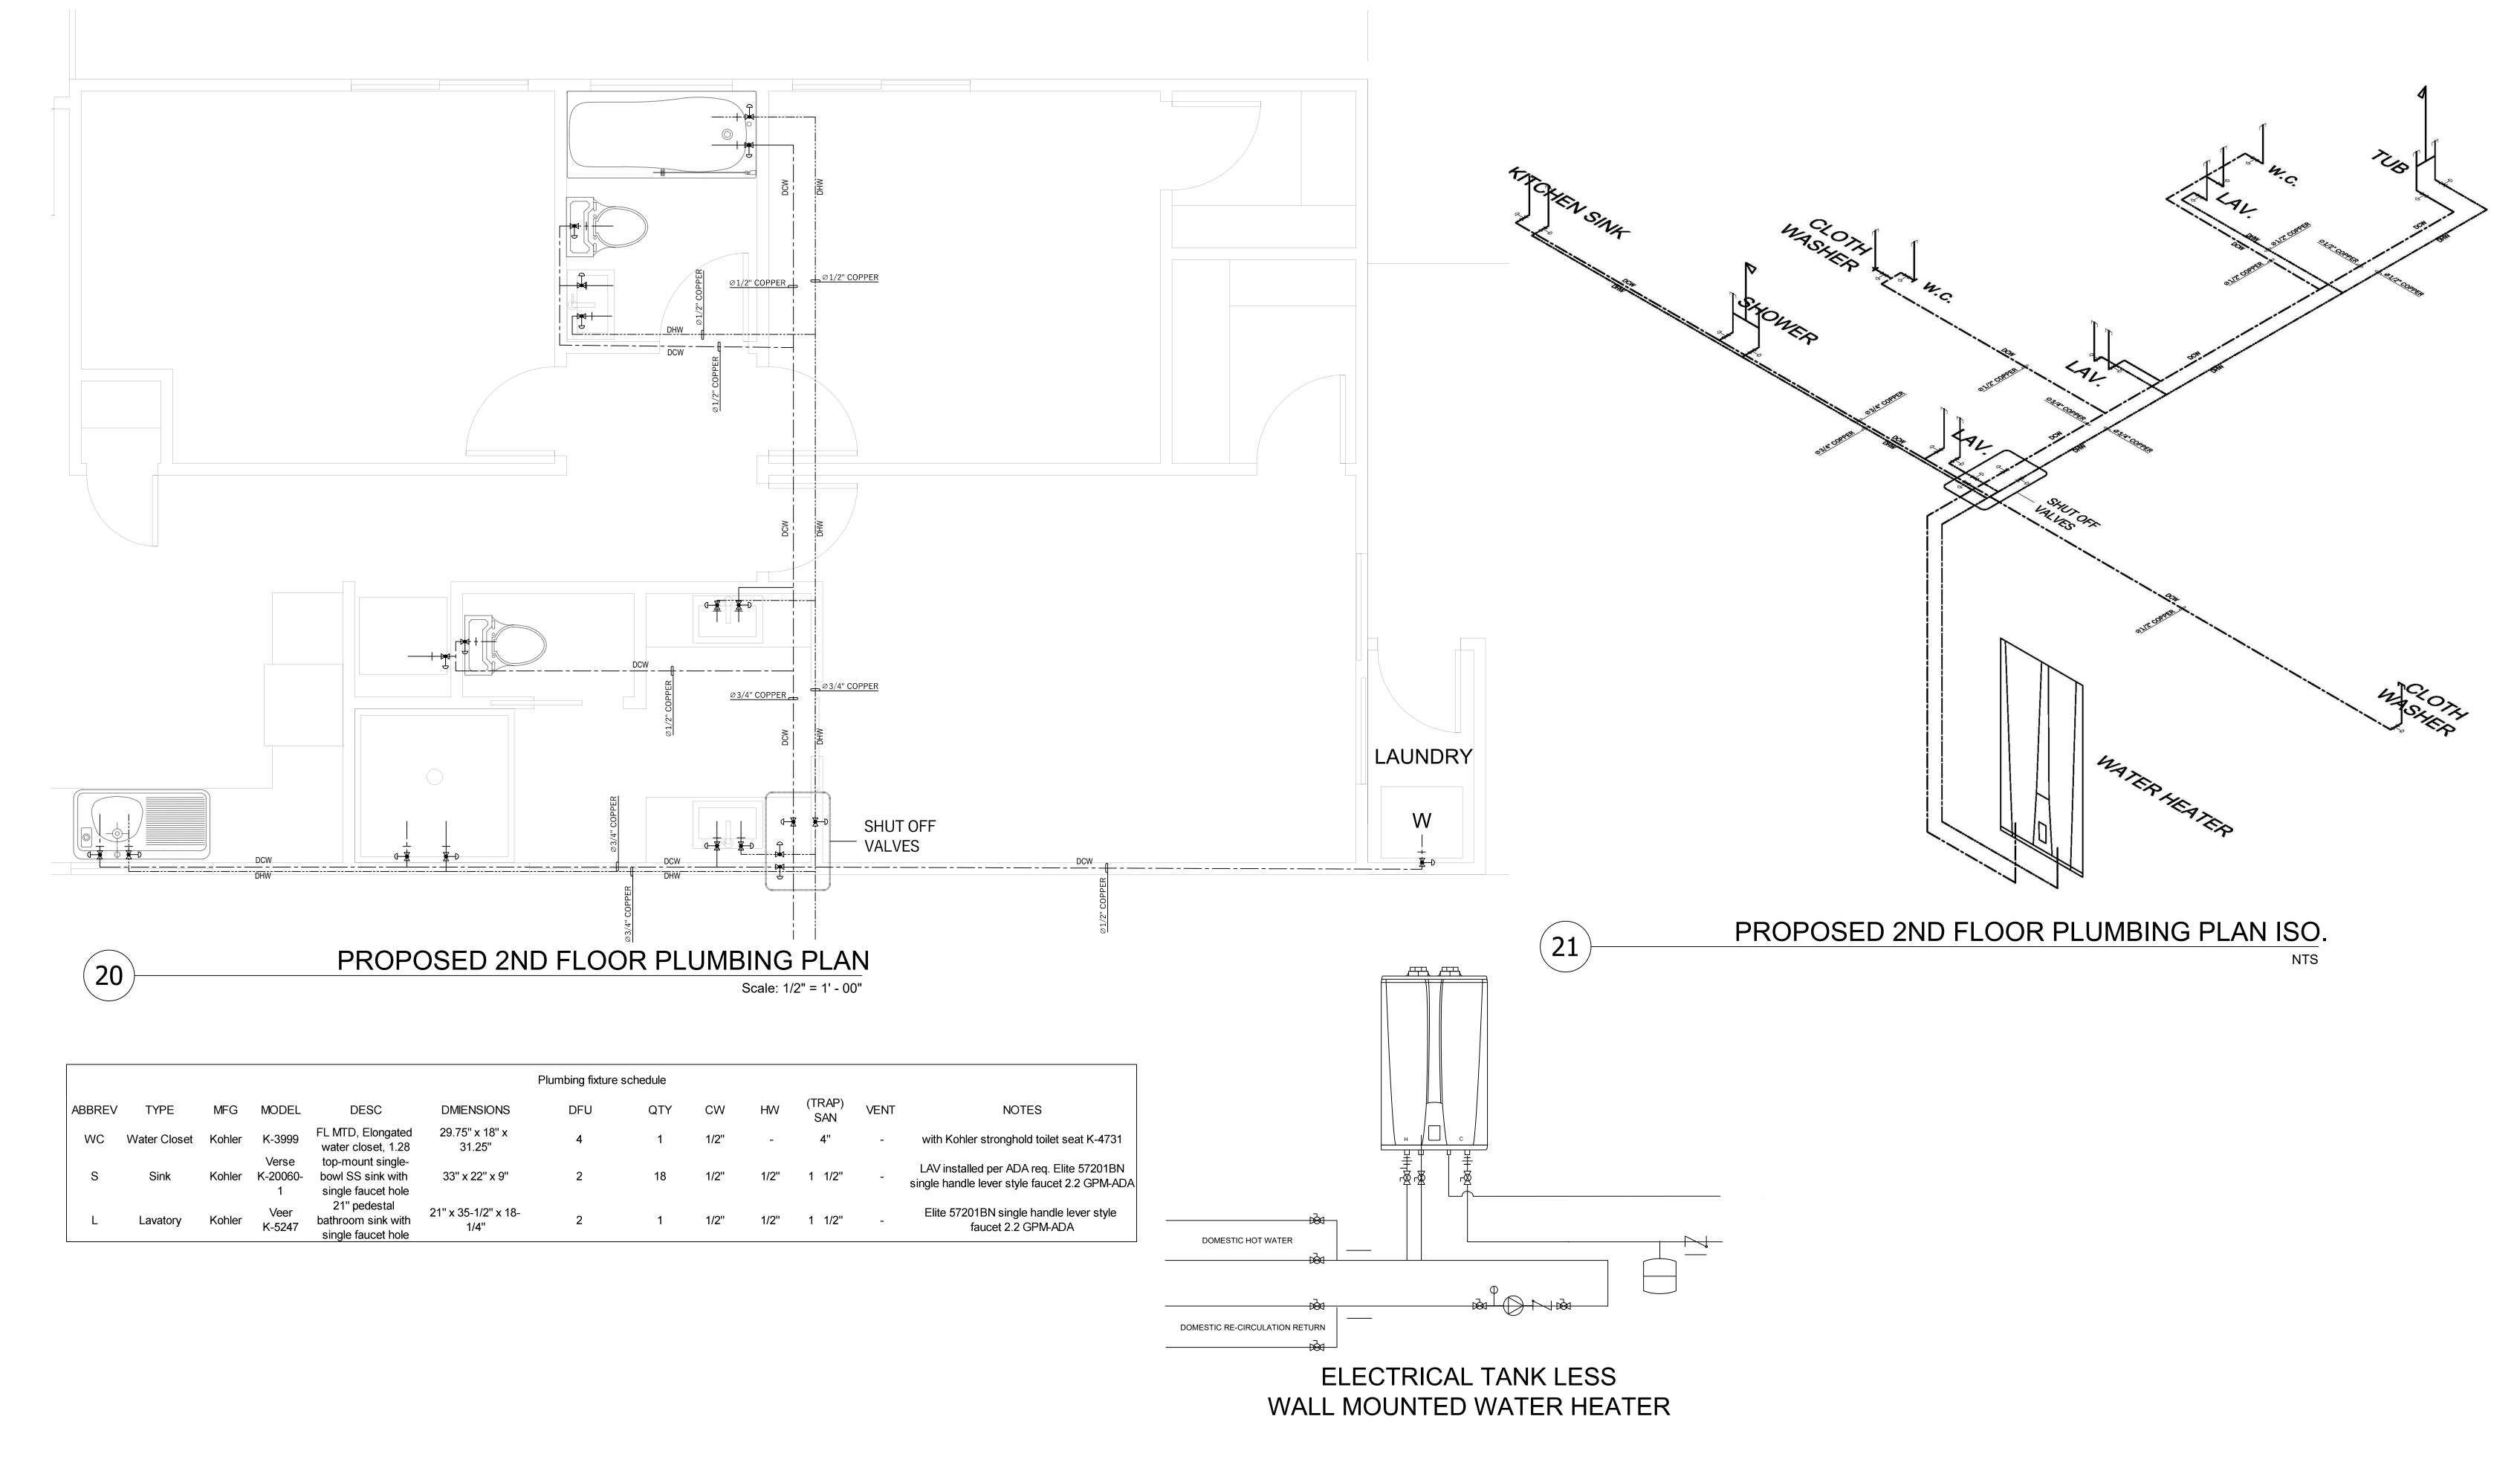
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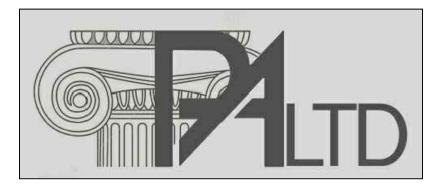
PROPOSED ADDITION FOR

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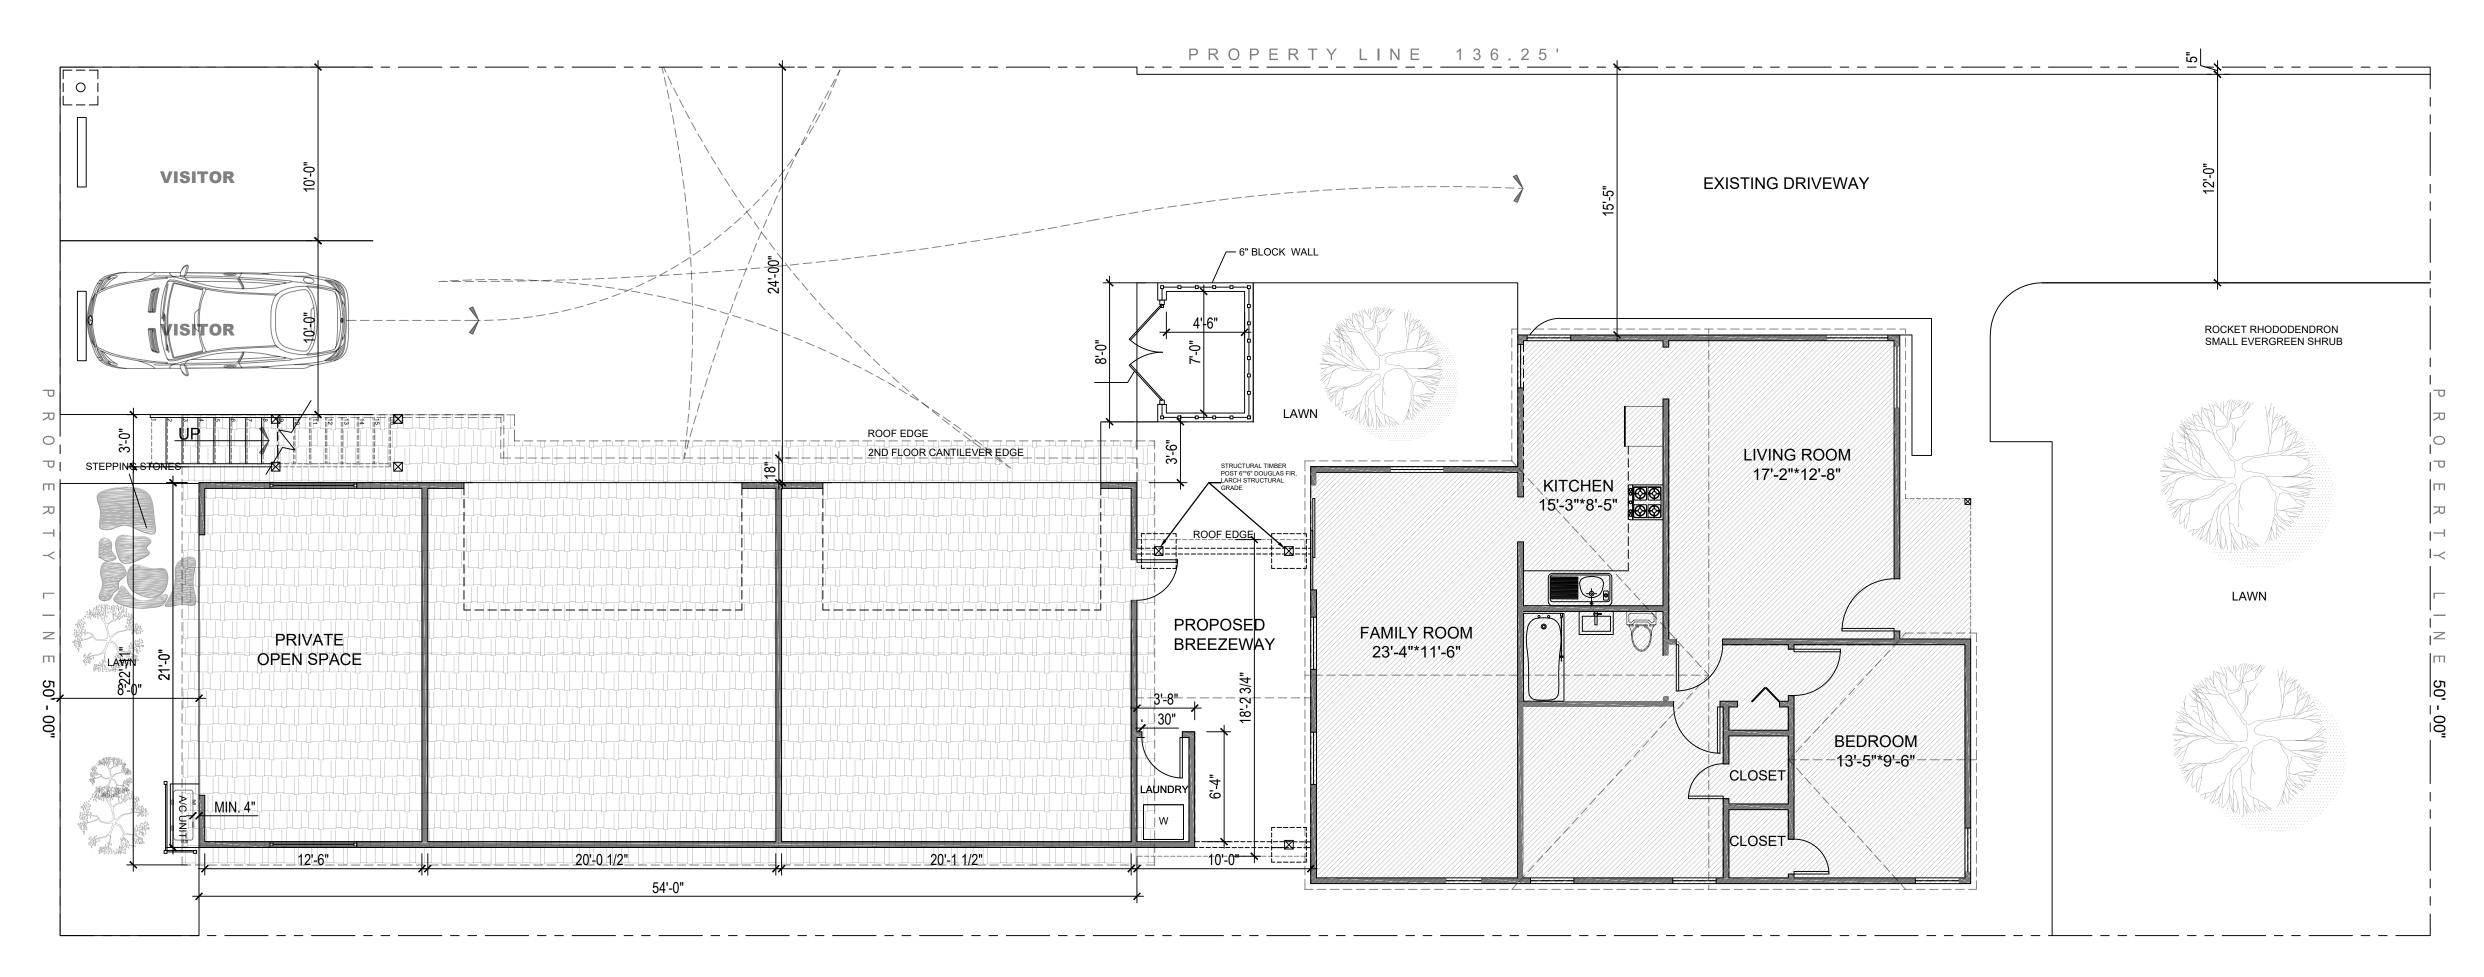
GILBERT SCALES


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PROPOSED ADDITION FOR

GILBERT SCALES


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GILBERT SCALES

8708 FLOWER ST, BELLFLOWER, CA, 90706

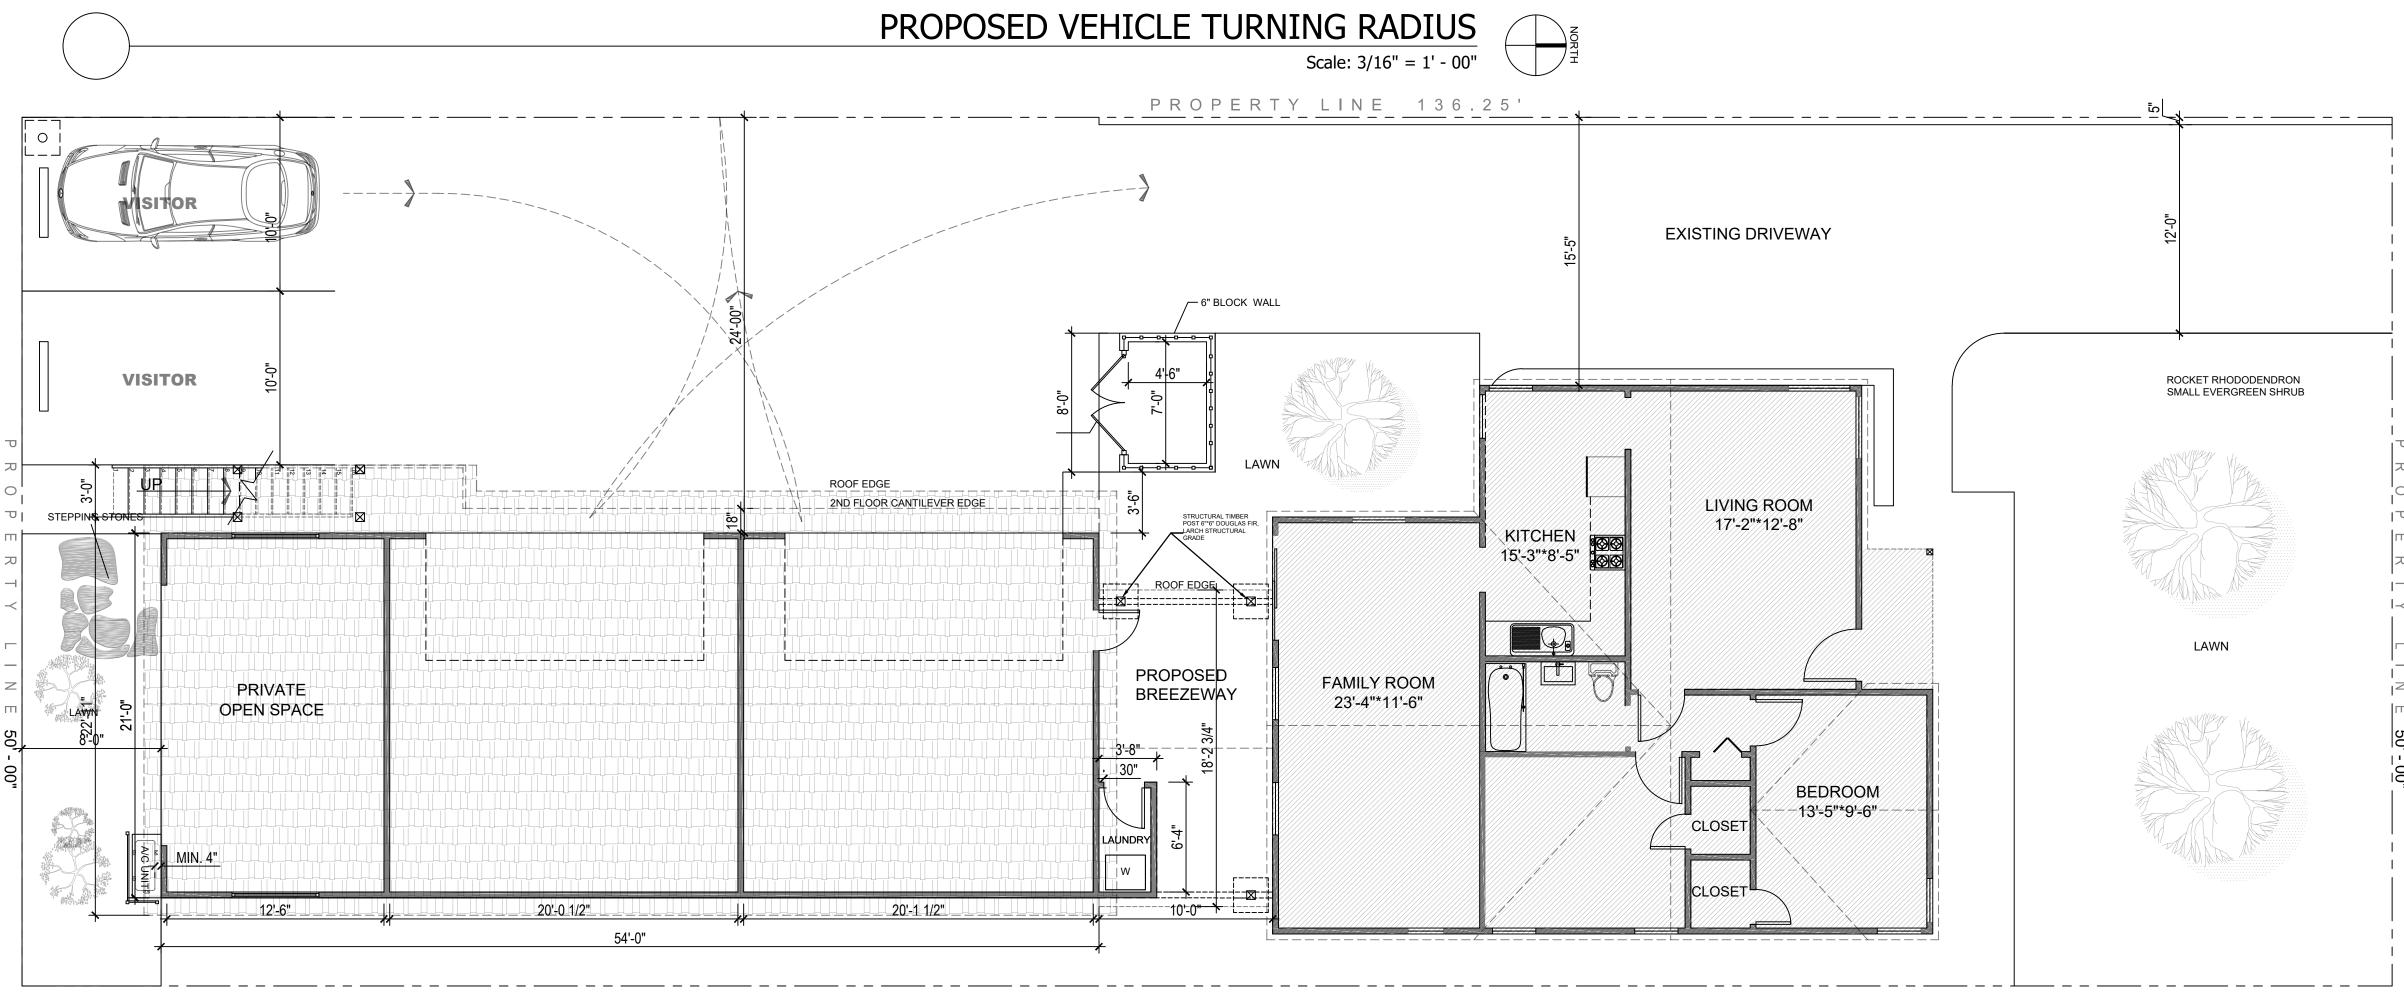Date:
APRIL. 26, 2018

Scale:
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PROPOSED VEHICLE TURNING RADIUS DIAGRAM


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PROPOSED ADDITION FOR **GILBERT SCALES**
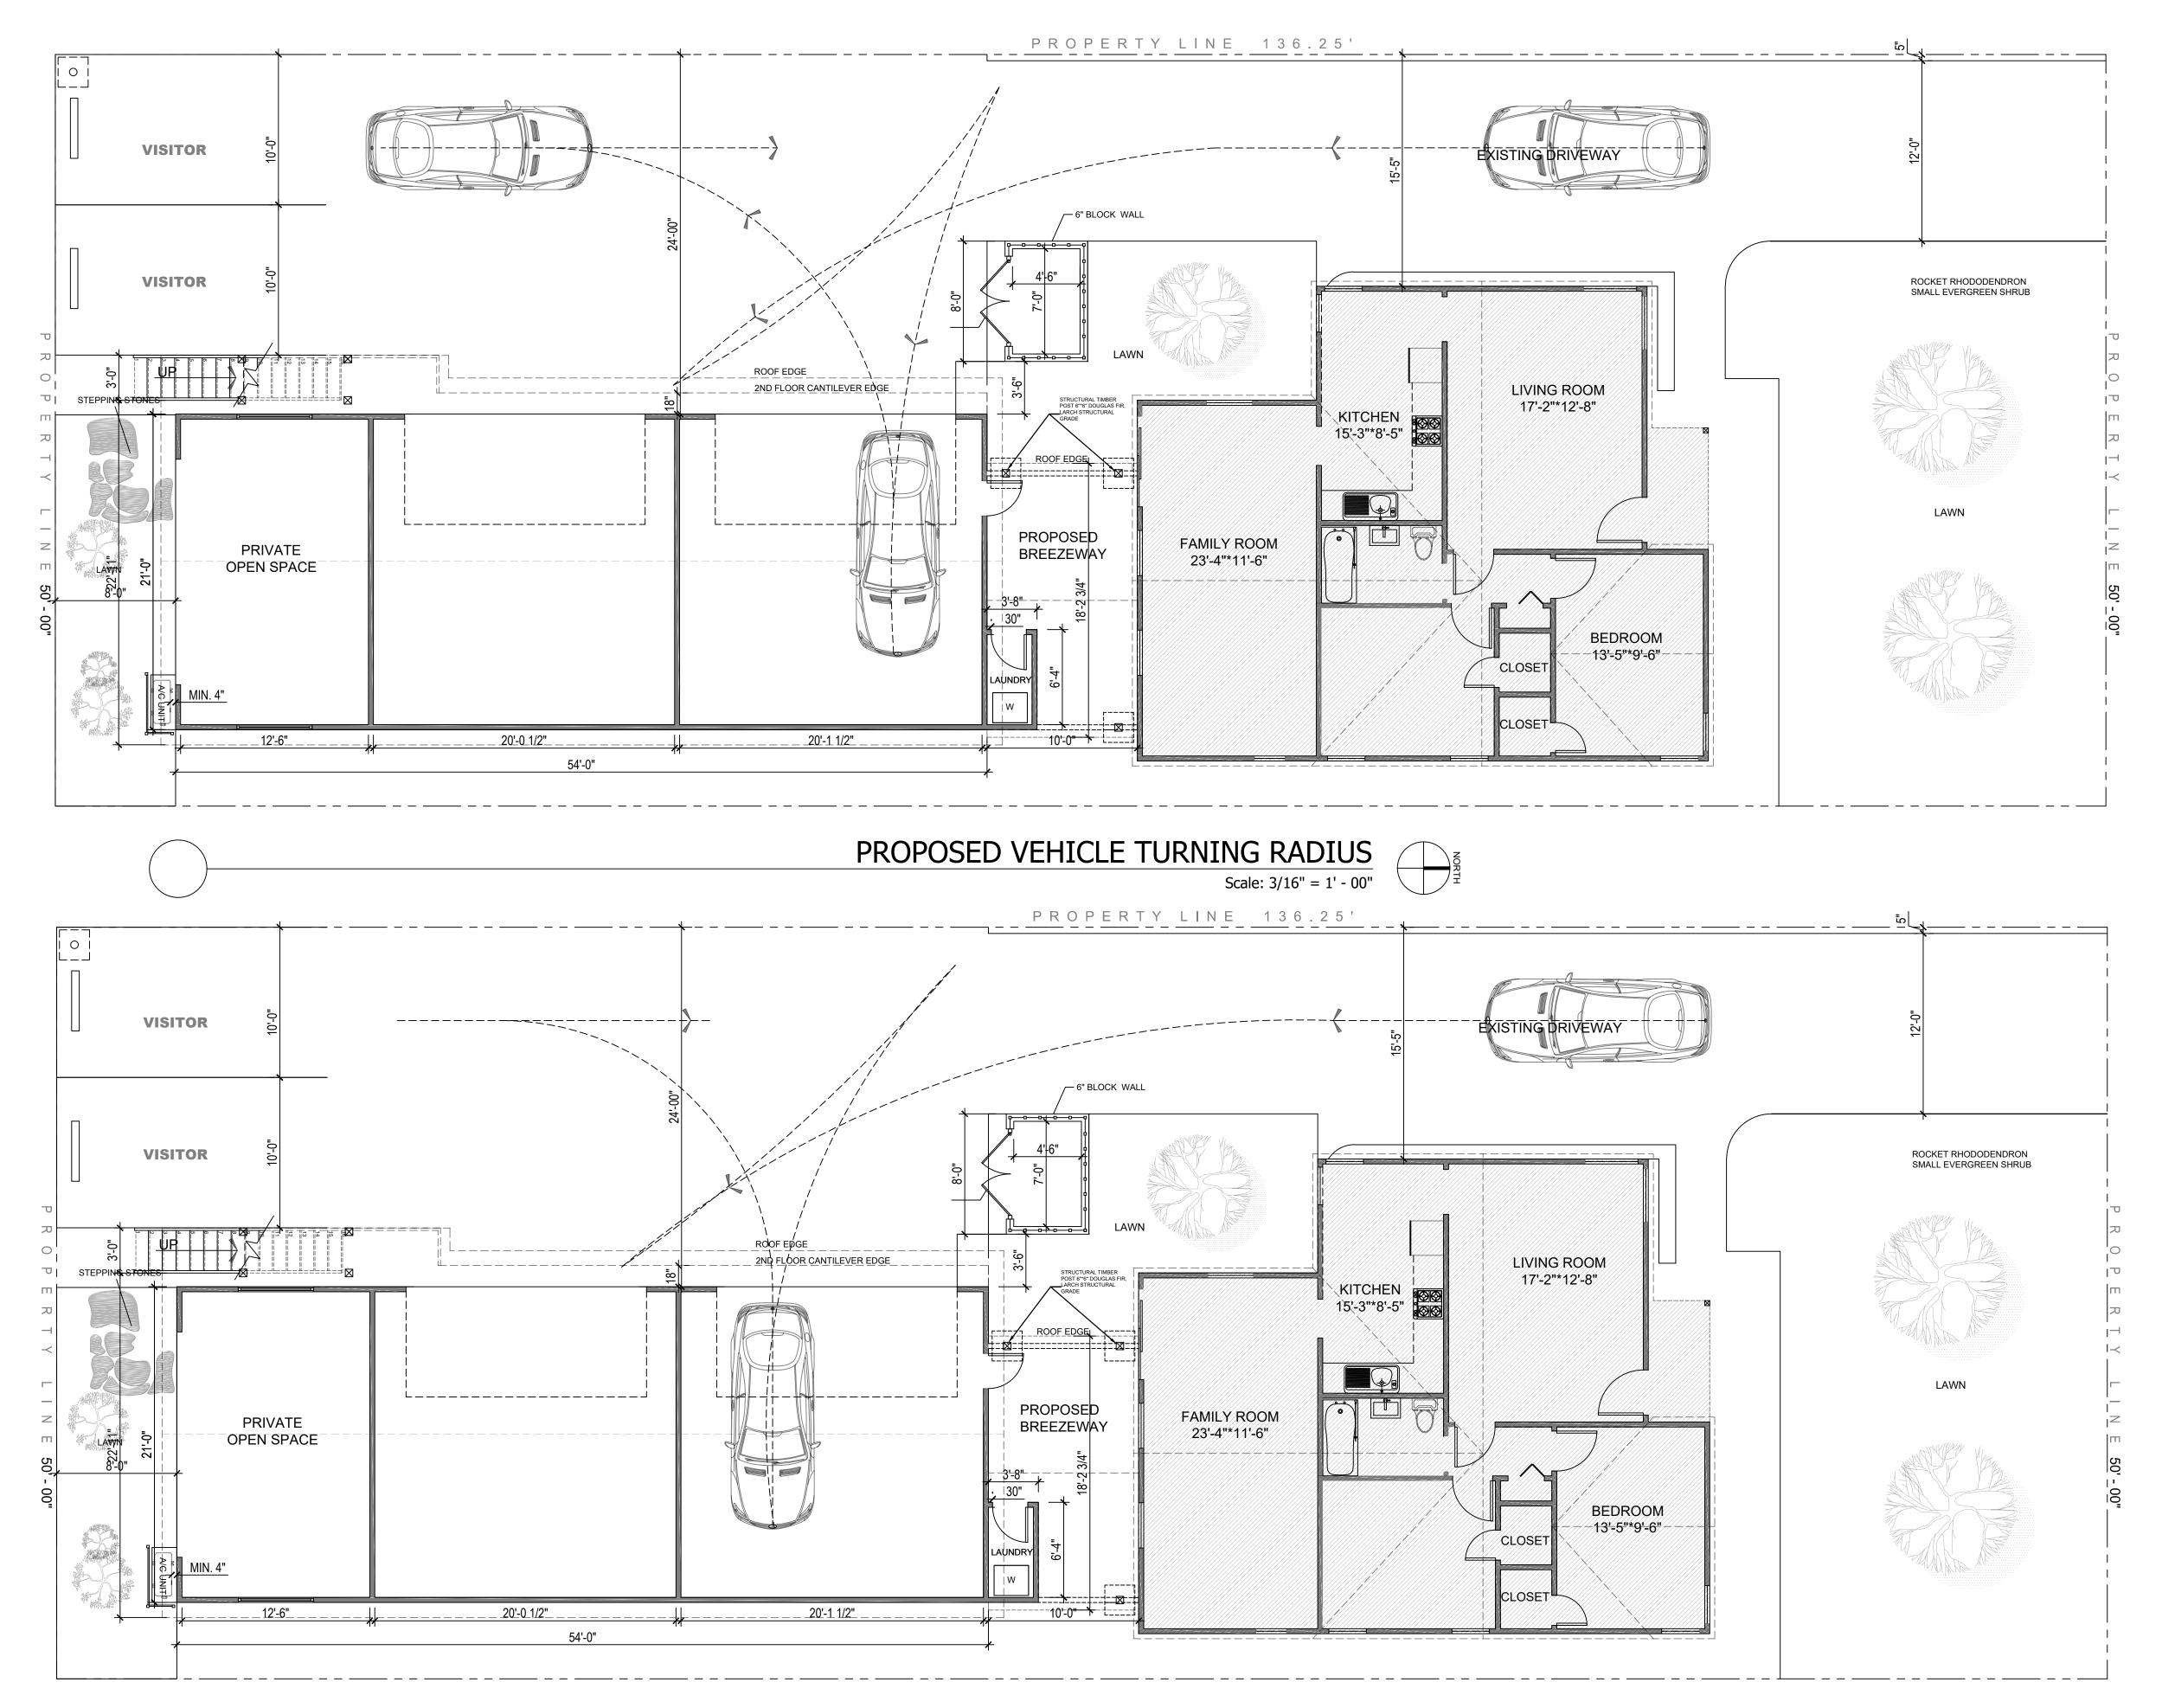
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Revision/Issue Preliminary plan review submittal January 19, 2018
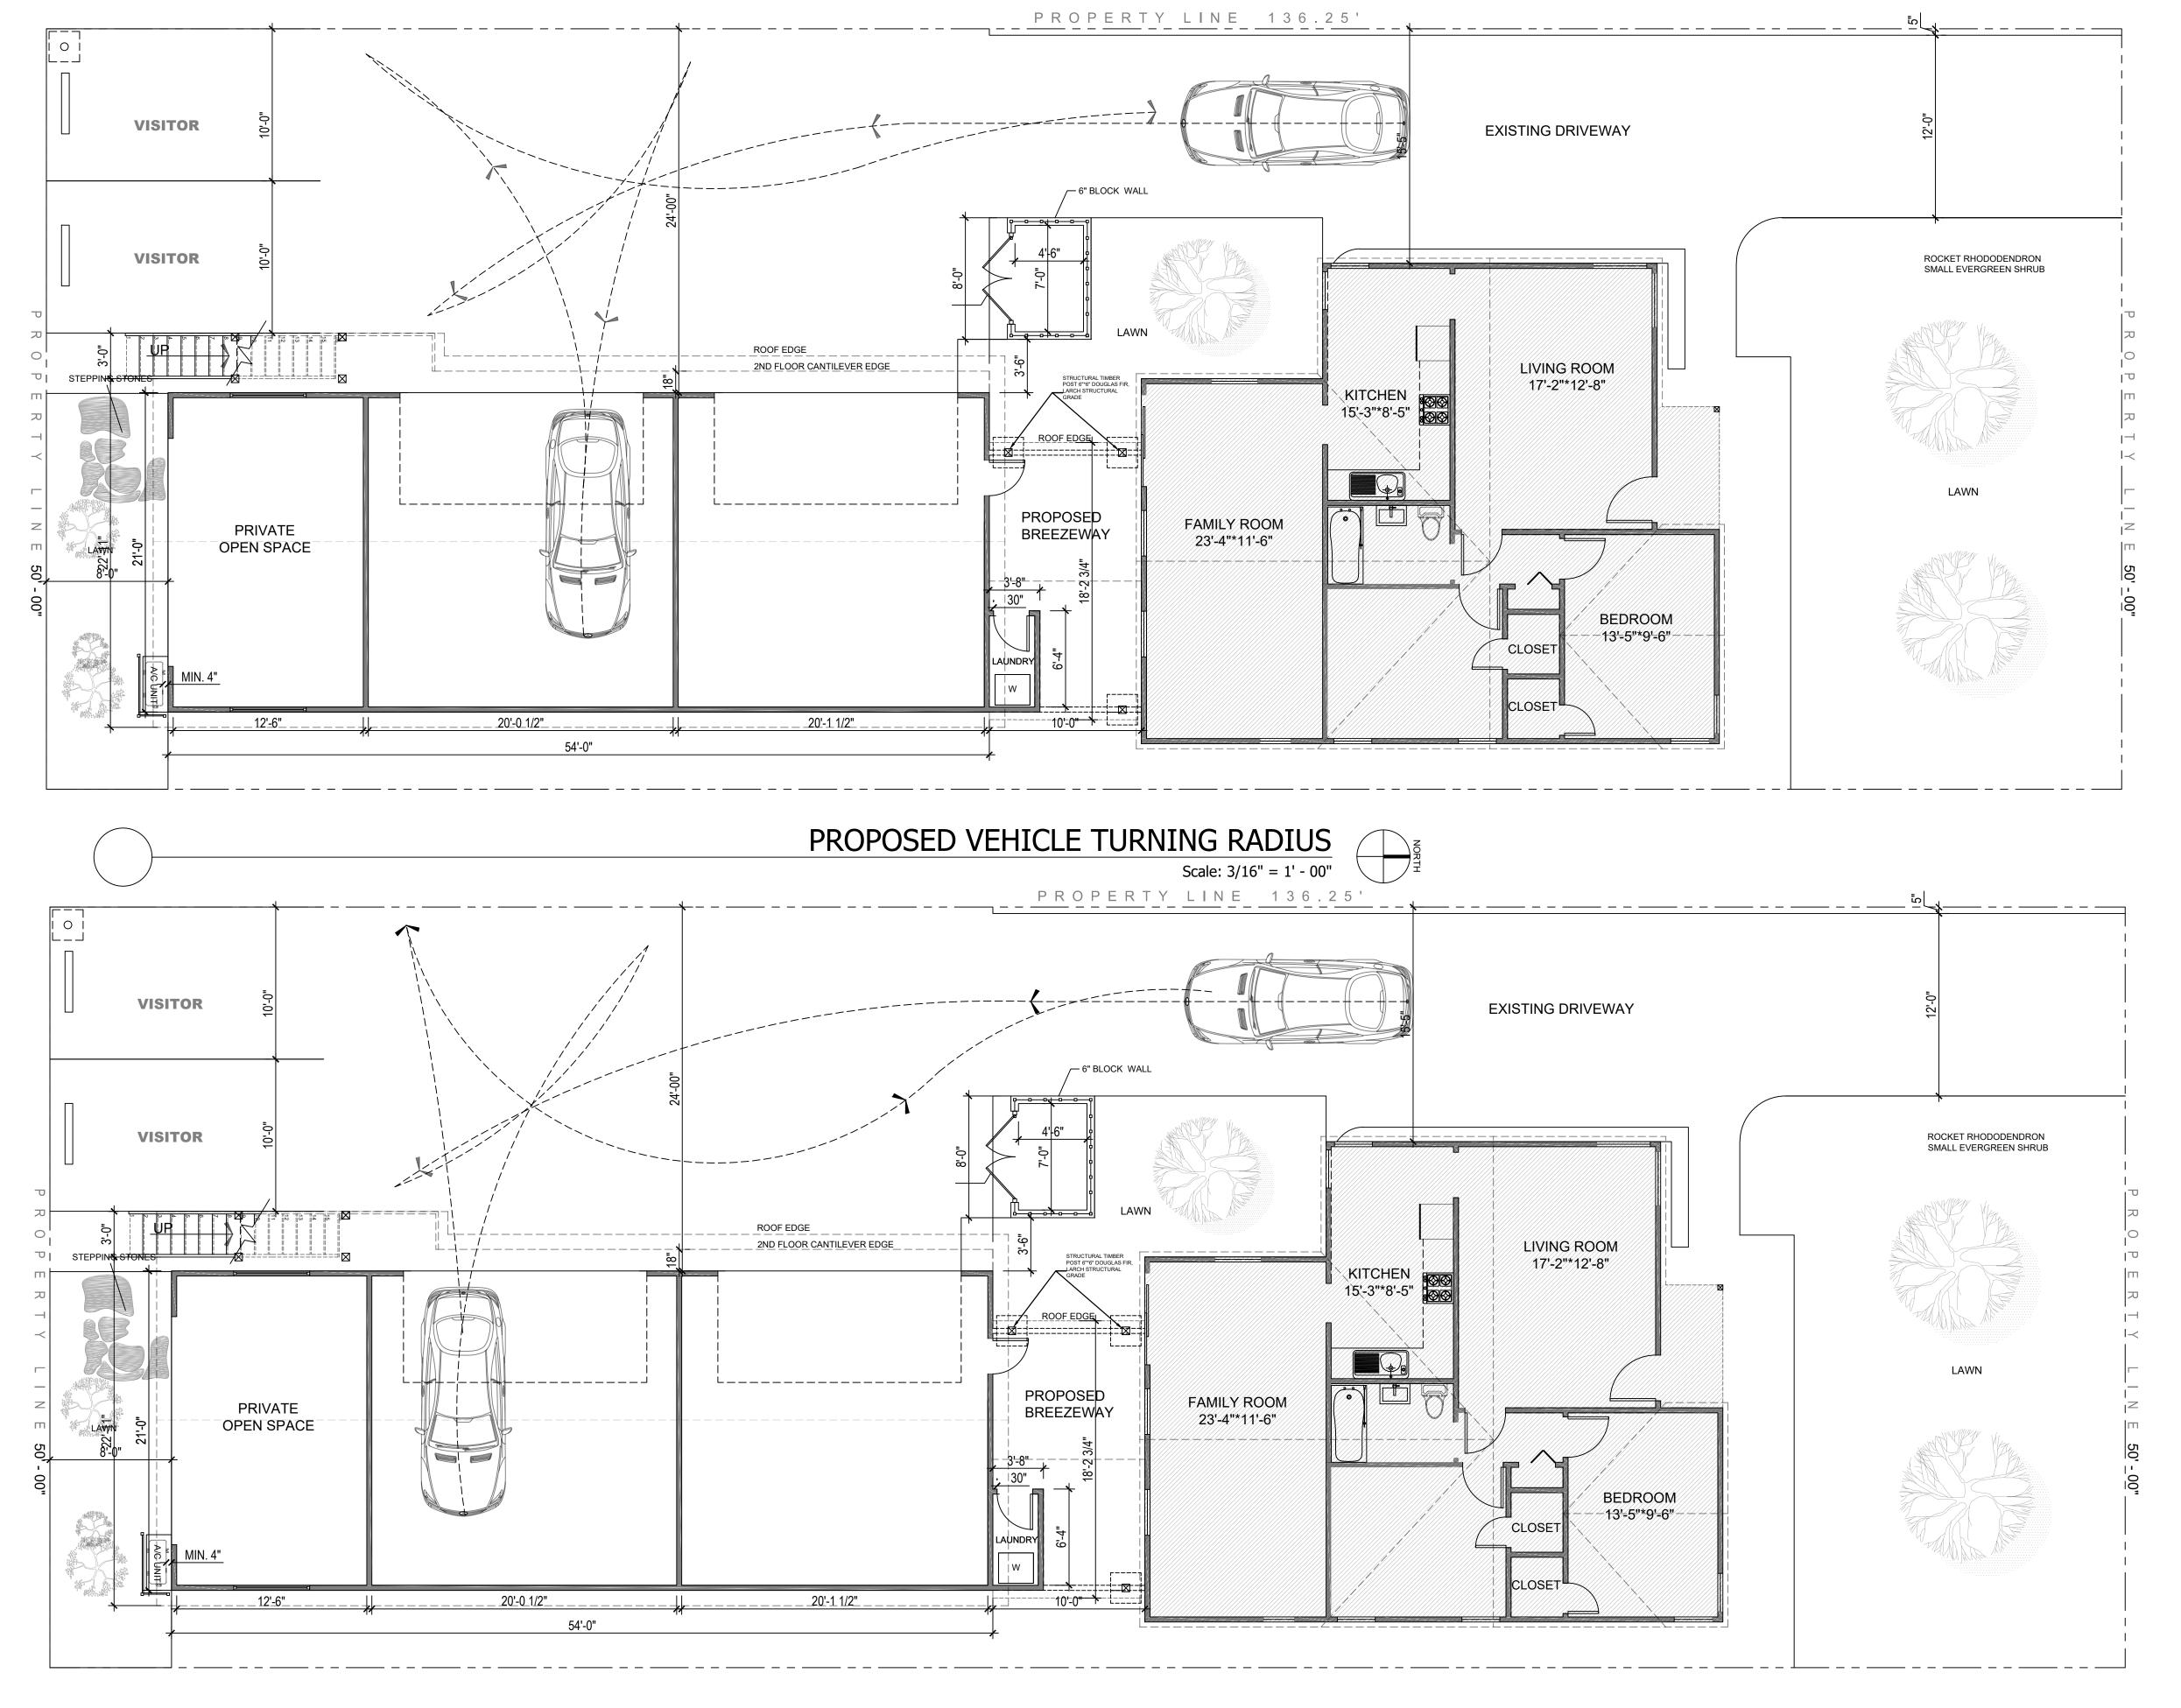
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